

Architectural Review Board

APPLICATION / INFORMATION SUMMARY

DEPARTMENT OF PLANNING AND ZONING 843-797-6220 EXT. 1118

______Date: 5-7-18

P.O. Drawer 1768

519 N. Goose Creek Blvd.

Goose Creek, South Carolina 29445-1768

www.cityofgoosecreek.com

Fax: 843-863-5208

Property Address: 111	LUMBER LANE		TMS No.:	
Review request:	For:		Preliminary meeting date requested: 5.21.16	
☐ Preliminary	□New Construction ■Alterations / Addition	S	Appeal Decision of Architectural Review Board	
⊠ Final	□Color Change □ Demolition □ Other_			
	TYRA MUELLER	Dayti	rlime phone: 843 899 3406	
	SRCHITECTS INC	Dayti	rtime phone: 843 884 1185	
ARB Meeting Representative	JOHN BELL	Cont	ntact Information: 843 884 1185	
Applicant's mailing address:	TIEN. MAPLE ST.			
City: SUMMERVI			e: SC Zip: 29483	
Applicant's e-mail address:	john@bellarchitectsin	C.	com	
Applicant's relationship:		Contra		
COLORS/F		ors, La	SING A4.1	
	Scope of Work: (please give a d	etailed	d description)	
LANDSCA	EXTERIOR OF EXISTING PING AT BUILDING A	Sas	D PARKING.	
the subject property or an auth	ignature below that the foregoing application is considered representative. I authorize the subject propal Review Board of the City of Goose Creek on the	erty to	to be posted and inspected, and the application	

Applicant's signature:

Print name legibly: JOHN







Job

Approvals

SPECIFICATIONS

Intended Use:

ALF is excellent for small floodlighting applications such as signs, façade, landscape accent or small area illumination. The compact, low profile size allows the flood to be easily hidden or blend into the landscape environment.

Construction:

- Low copper extruded aluminum construction provides long life in outdoor ground mounted applications. Ribbed design adds styling while dissipating LED and driver heat, providing longer component life.
- Tempered and impact resistant glass lens with decorative silk screen seals to housing with silicone gasket
- Dark Bronze powder paint finish provides durable and lasting appearance

Optics/Electrical LED:

- Six or twelve LEDs produce 1122 or 2303 lumens at 5000K
- Wide 6 x 5 beam spread covers three times the set back distance with uniform light
- Universal voltage driver is 120-277V*, 50/60hz, with 10.2 input watts (ALF-6LU) 20.9 input watts (ALF-12LU)
- Ambient operating temperature -40°C to 40°C

*In Canada, ALF should be used for voltages 120-240 only

Type

Installation:

- Knuckle mount: Universal ½" 14 NPS swivel knuckle has serrated teeth for sure aiming.
 Knuckle threads are brass insuring quality installation and corrosion resistance
- Wall mount: Cast aluminum cover/quick mount plate and universal adapter allows easy installation to 3-1/2 or 4" standard junction boxes

Listings:

Listed to UL 1598 for use in wet locations


• ALF-6 IP65 • ALF-12 IP64


Warranty:

Five year limited warranty (for more information visit: http://www.hubbelloutdoor.com/resources/warranty/

PRODUCT IMAGE(S)



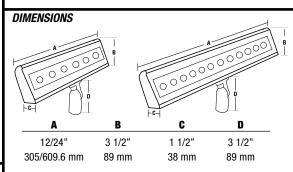

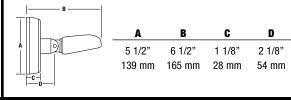

CERTIFICATIONS/ LISTINGS



IP64 IP65

tradeSELECT

SHIPPING INFORMATION


Cotolou	C W/Irw\/	Ca	Carton Qty.		
Catalog Number	G.W(kg)/ CTN	Length Inch (cm)	Width Inch (cm)	Height Inch (cm)	per Master Pack
ALF-6LU	9.7 (4.4)	18.5 (47)	14.3 (36.5)	5.7 (14.5)	2
ALFW-6LU-PC	11. 4 (5.2)	18.5 (47)	14.3 (36.5)	5.7 (14.5)	2
ALF-12LU	6.5 (2.97)	24.8 (63)	8.8 (22.5)	3.14 (8)	1

ORDERING INFORMATION

ORDERING EXAMPLE: ALF-6LU-5K-BZ

Catalog Number	Wattage	Number of LEDs	Voltage ¹	Lumens	Life	LPW	CCT	Weight lbs. (kg)
1/2" KNUCKLE MOUNT								
ALF-6LU-5K-BZ	10.2	6	120-277V	1122	50,000 hrs	110	5000K	4.0 (1.8)
ALF-12LU-5K-BZ	20.9	12	120-277V	2303	50,000 hrs	110	5000K	8.0 (3.6)
	WALLMOUNT							
ALFW-6LU-5K-BZ-PC	10.7	6	120V	510	50,000 hrs	48	5000K	4.5 (2.0)

¹ Unit should not be used above 240V in Canada

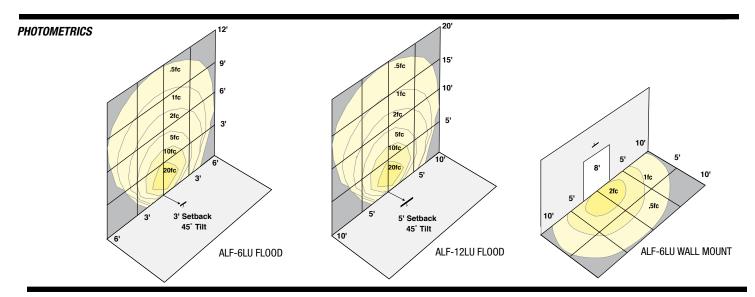

PERFORMANCE DATA

# OF LEDS	DRIVE CURRENT	ССТ	LUMENS	BEAM (H X V)	LPW ¹
6	STD. (470mA)	5K	1122	6 x 5	110
12	STD. (470mA)	5K	2303	6 x 5	110

Lumen values are from photometric tests performed in accordance with IESNA LM-79-08. Data is considered to be representative of the configurations shown. Actual performance may differ as a result of end-user environment and application.

ELECTRICAL DATA

	DRIVE CURRENT	INPUT VOLTAGE	SYSTEM POWER	CURRENT	POWER
# OF LEDS	(mA)	(V)	(w)	(Amps)	FACTOR
6	STD. (470mA)	120	10.1	.09	.97
0		277	12.5	.06	.78
12	STD. (470mA)	120	21.0	.18	.98
12	31D. (470IIIA)	277	25.5	.12	.78



FEATURES & SPECIFICATIONS

INTENDED USE — The OLCS provides years of maintenance-free general illumination for residential and commercial outdoor applications such as walkways, doorways/entrances, columns, and stairways.

CONSTRUCTION — Rugged cast-aluminum housing is protected by a thermoset powder coat finish that provides superior resistance to corrosion and weathering. A tightly controlled multi-stage process ensures a minimum 3 mils thickness for a finish that can withstand extreme climate changes without cracking or peeling.

Polycarbonate LED lens/cover protects LEDs.

Fixture weight = 2.4 lbs.

OPTICS — 48 high-performance LEDs produce up to 513 lumens and maintain 70% of light output at 50,000 hours of service.

(LED lifespan based on IESNA LM-80-08 results and calculated per IESNA TM-21-11 methodology.) White polycarbonate diffuser provides a soft white light at 4000K CCT.

See Lighting Facts Labels for specific fixture performance.

ELECTRICAL — Fixture operates at 120 volts, 60 Hz.

Standard input = 8.9 watts.

Operating temperature: -30°C to 40°C.

Amps @ 120V = .076.

Surge protection = 2.5kV.

INSTALLATION — Mounts easily to recessed junction box (by others).

LISTINGS — UL Listed to U.S. and Canadian safety standards for wet locations.

Designed for wall mounting more than 4' above the ground.

Tested in accordance with IESNA LM-79 and LM-80 standards.

WARRANTY — 5-year limited warranty. Complete warranty terms located at www.acuitybrands.com/CustomerResources/Terms_and_conditions.aspx

Actual performance may differ as a result of end-user environment and application.

Note: Specifications subject to change without notice.

atalog lumber
lotes
уре



Outdoor General Purpose

OLCS

OUTDOOR LED CAST SCONCE












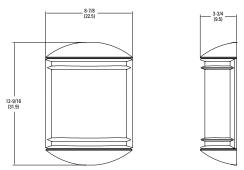

All dimensions are inches (centimeters) unless otherwise indicated

ORDERING INFO	RMATION All configurations of this product are	Example: OLCS 8 DDB		
OLCS				
Series	Light engines	Color temperature (CCT) ¹	Voltage	Finish
OLCS	8	(blank) 4000K	(blank) (120V)	DDB Dark bronze
				WH White

Notes


1 Nominal Correlated Color Temperature (CCT) per ANSI C78.377-2008.


DECORATIVE INDOOR & OUTDOOR OLCS


PHOTOMETRIC DIAGRAMS


To see complete photometric reports or download .ies files for this product, visit www.Lithonia.com. Tested in accordance with IESNA LM-79 and LM-80 standards.


OLCS

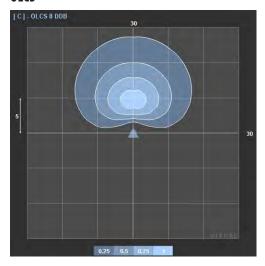

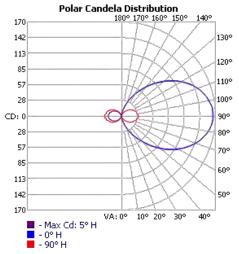

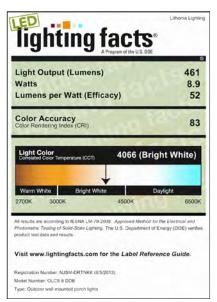

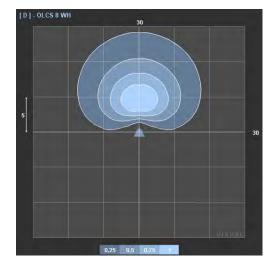

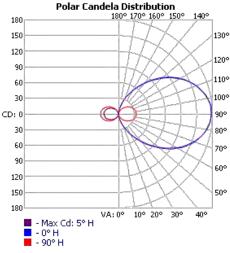



DESCRIPTION

The patented Lumark Crosstour™ MAXX LED wall pack series of luminaries provides low-profile architectural style with super bright, energy-efficient LEDs. The rugged die-cast aluminum construction, back box with secure lock hinges, stainless steel hardware along with a sealed and gasketed optical compartment make Crosstour impervious to contaminants. The Crosstour MAXX wall luminaire is ideal for wall/ surface, inverted mount for facade/canopy illumination, perimeter and site lighting. Typical applications include pedestrian walkways, building entrances, multi-use facilities, industrial facilities, perimeter parking areas, storage facilities, institutions, schools and loading docks.

Catalog #	Туре
Project	
Comments	Date
Prepared by	

SPECIFICATION FEATURES

Construction

Low-profile LED design with rugged one-piece, die-cast aluminum back box and hinged removable door. Matching housing styles incorporate both a full cutoff and refractive lens design. Full cutoff and refractive lens models are available in 58W, 81W and 102W. Patent pending secure lock hinge feature allows for safe and easy tool-less electrical connections with the supplied push-in connectors. Back box includes four 1/2" NPT threaded conduit entry points. The back box is secured by four lag bolts (supplied by others). External fin design extracts heat from the fixture surface. One-piece silicone gasket seals door and back box. Not recommended for car wash applications.

Optical

Silicone sealed optical LED chamber incorporates a custom engineered reflector providing high-efficiency illumination. Full cutoff models integrate an impactresistant molded refractive prism optical lens assembly meeting requirements for Dark Sky compliance. Refractive lens models incorporate a molded lens

assembly designed for maximum forward throw. Solid state LED Crosstour MAXX luminaries are thermally optimized with eight lumen packages in cool 5000K, neutral 4000K, or warm 3000K LED color temperature (CCT).

Electrical

LED driver is mounted to the die-cast aluminum housing for optimal heat sinking. LED thermal management system incorporates both conduction and natural convection to transfer heat rapidly away from the LED source, 58W. 81W and 102W models operate in -40°C to 40°C [-40°F to 104°F]. High ambient 50°C [122°F] models available in 58W and 81W models only, Crosstour MAXX luminaires. maintain greater than 89% of initial light output after 72,000 hours of operation. Four half-inch NPT threaded conduit entry points allow for thru-branch wiring. Back box is an authorized electrical wiring compartment. Integral LED electronic driver incorporates surge protection. 120-277V 50/60Hz, 480V 60Hz, or 347V 60Hz electrical operation. 480V is compatible for use with 480V Wye systems only.

Emergency Egress

Optional integral cold weather battery emergency egress includes emergency operation test switch (available in 58W and 81W models only), an AC-ON indicator light and a premium extended rated sealed maintenance-free nickel-metal hydride battery pack. The separate emergency lighting LEDs are wired to provide redundant emergency lighting. Listed to UL Standard 924, Emergency Lighting.

Area and Site Pole Mounting

Optional extruded aluminum 6-1/2' arm features internal bolt guides for supplied twin support rods, allowing for easy positioning of the fixture during installation to pole. Supplied with round plate adapter plate. Optional tenon adapter fits 2-3/8" or 3-1/2" O.D. Tenon.

Finish

Crosstour MAXX is protected with a super TGIC carbon bronze or summit white polvester powder coat paint. Super TGIC powder coat paint finishes withstand extreme climate conditions while providing optimal color and gloss retention of the installed life.

Warranty

Five-year warranty.

Lumark



XTOR **CROSSTOUR** MAXX LED

APPLICATIONS: WALL / SURFACE **INVERTED** SITE LIGHTING





CERTIFICATION DATA

UL/cUL Wet Location Listed LM79 / LM80 Compliant **ROHS Compliant** NOM Compliant Models 3G Vibration Tested UL924 Listed (CBP Models) IP66 Rated DesignLights Consortium® Qualified*

TECHNICAL DATA


40°C Ambient Temperature External Supply Wiring 90°C Minimum

Effective Projected Area (Sq. Ft.): XTOR6B, XTOR8B, XTOR12B=0.54 With Pole Mount Arm=0.98

SHIPPING DATA:

Approximate Net Weight: 12-15 lbs. [5.4-6.8 kgs.]


DIMENSIONS

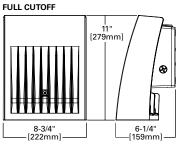


€)

ARM DRILLING


DEEP BACK BOX

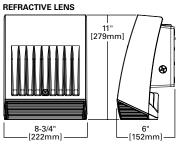


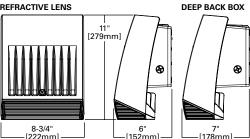

ESCUTCHEON PLATES

OPTIONAL POLE MOUNT ARM

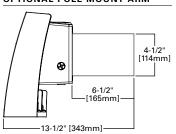

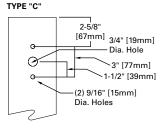

19-1/4" [489mm] -19-1/4" [489mm]


TD514005EN April 18, 2018 8:58 AM

111 Lumber Lane Renovations

Exterior Color Samples Final ARB Submittal




Walls

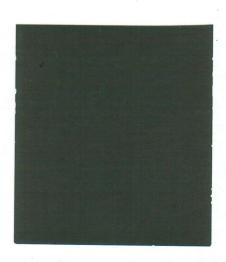


Canopy Roofs,
Rake Trim, Gutters,
Doors, Windows,
Exposed Steel Frames




Wainscot Trim

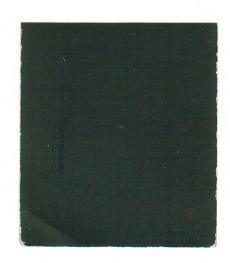

Slat at Fencing

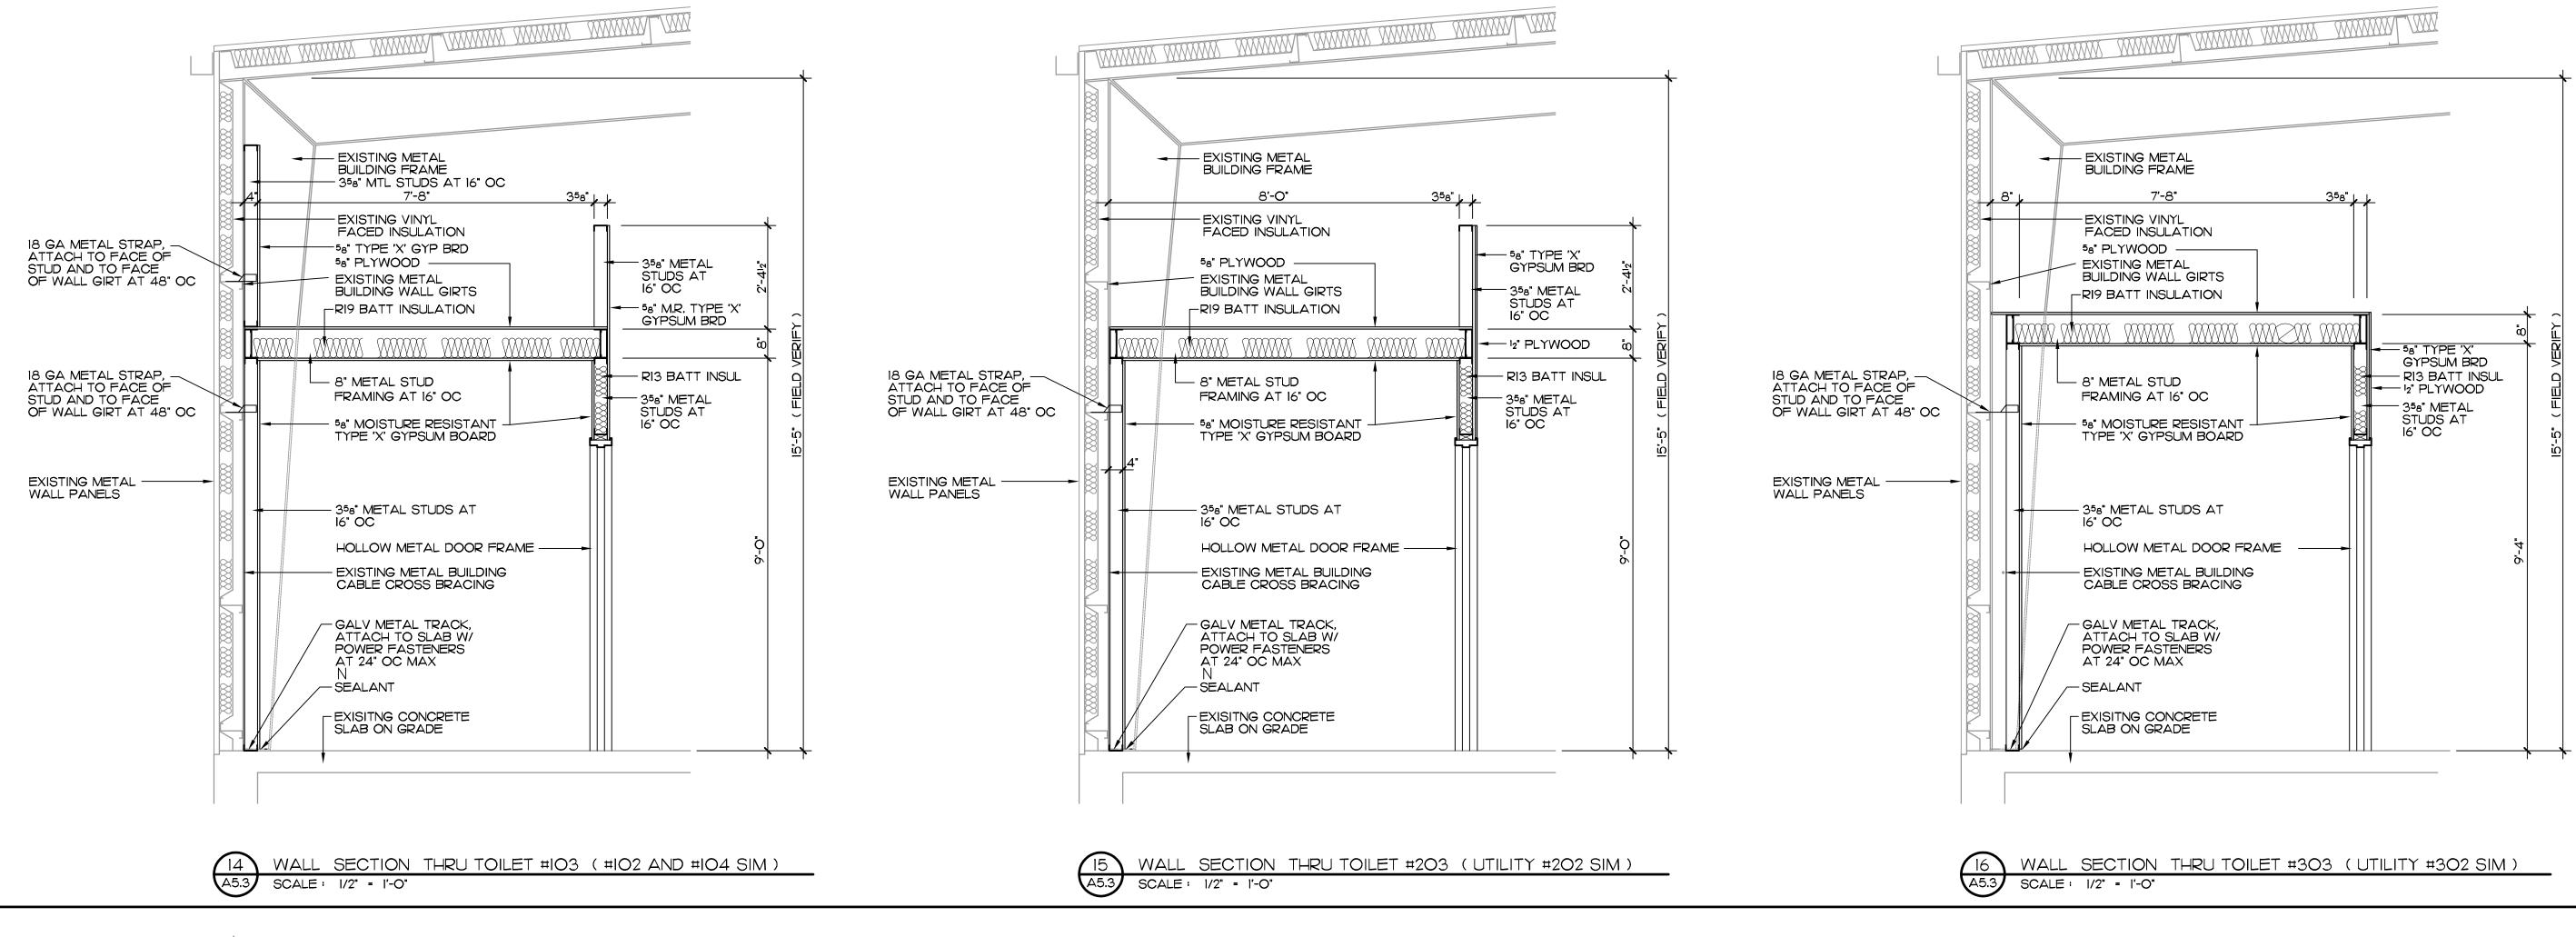

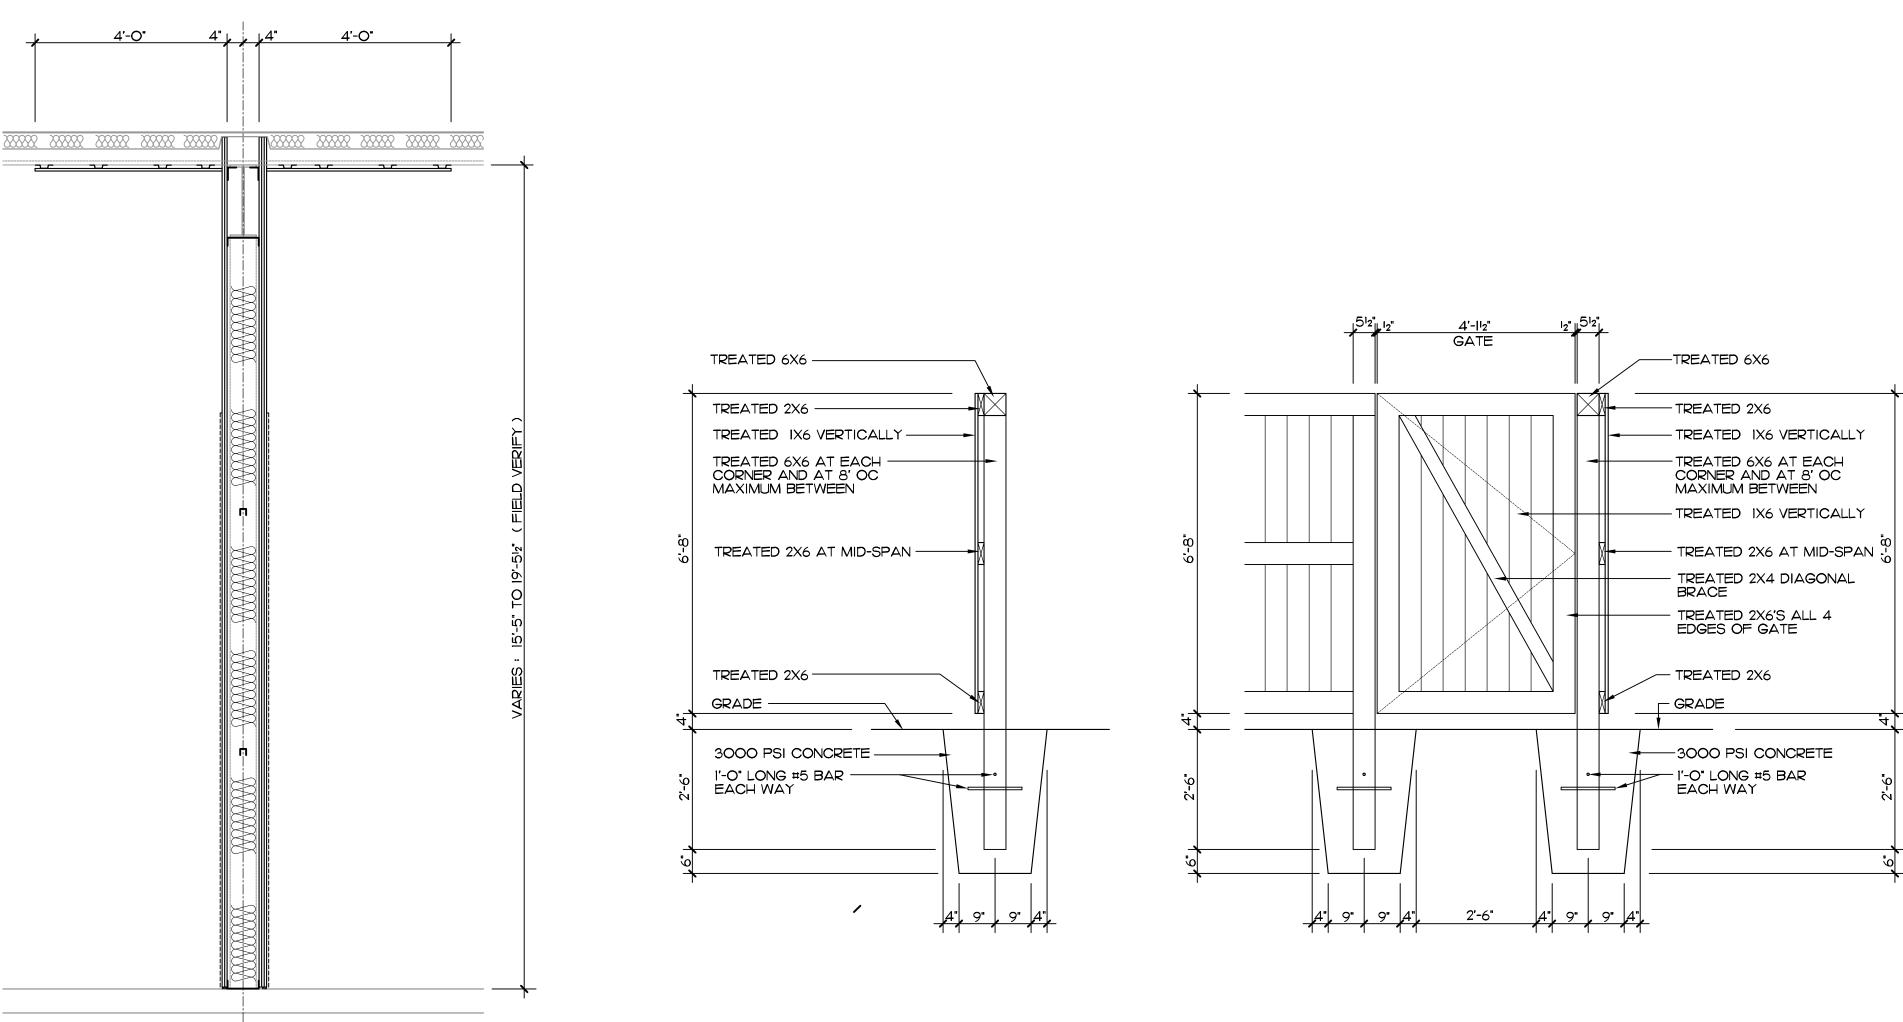

Bell Architects

BELL ARCHITECTS, INC.

SUMMERVILLE, SC

843-884-1185

RENOVATIONS

III LUMBER LANE GOOSE CREEK, SC


FINAL DESIGN

Date • 5-7-18 File No. • 18034

Design : J.E. BELL
Drawn : J.E. BELL
Checked:

No Date Revision

A5.3

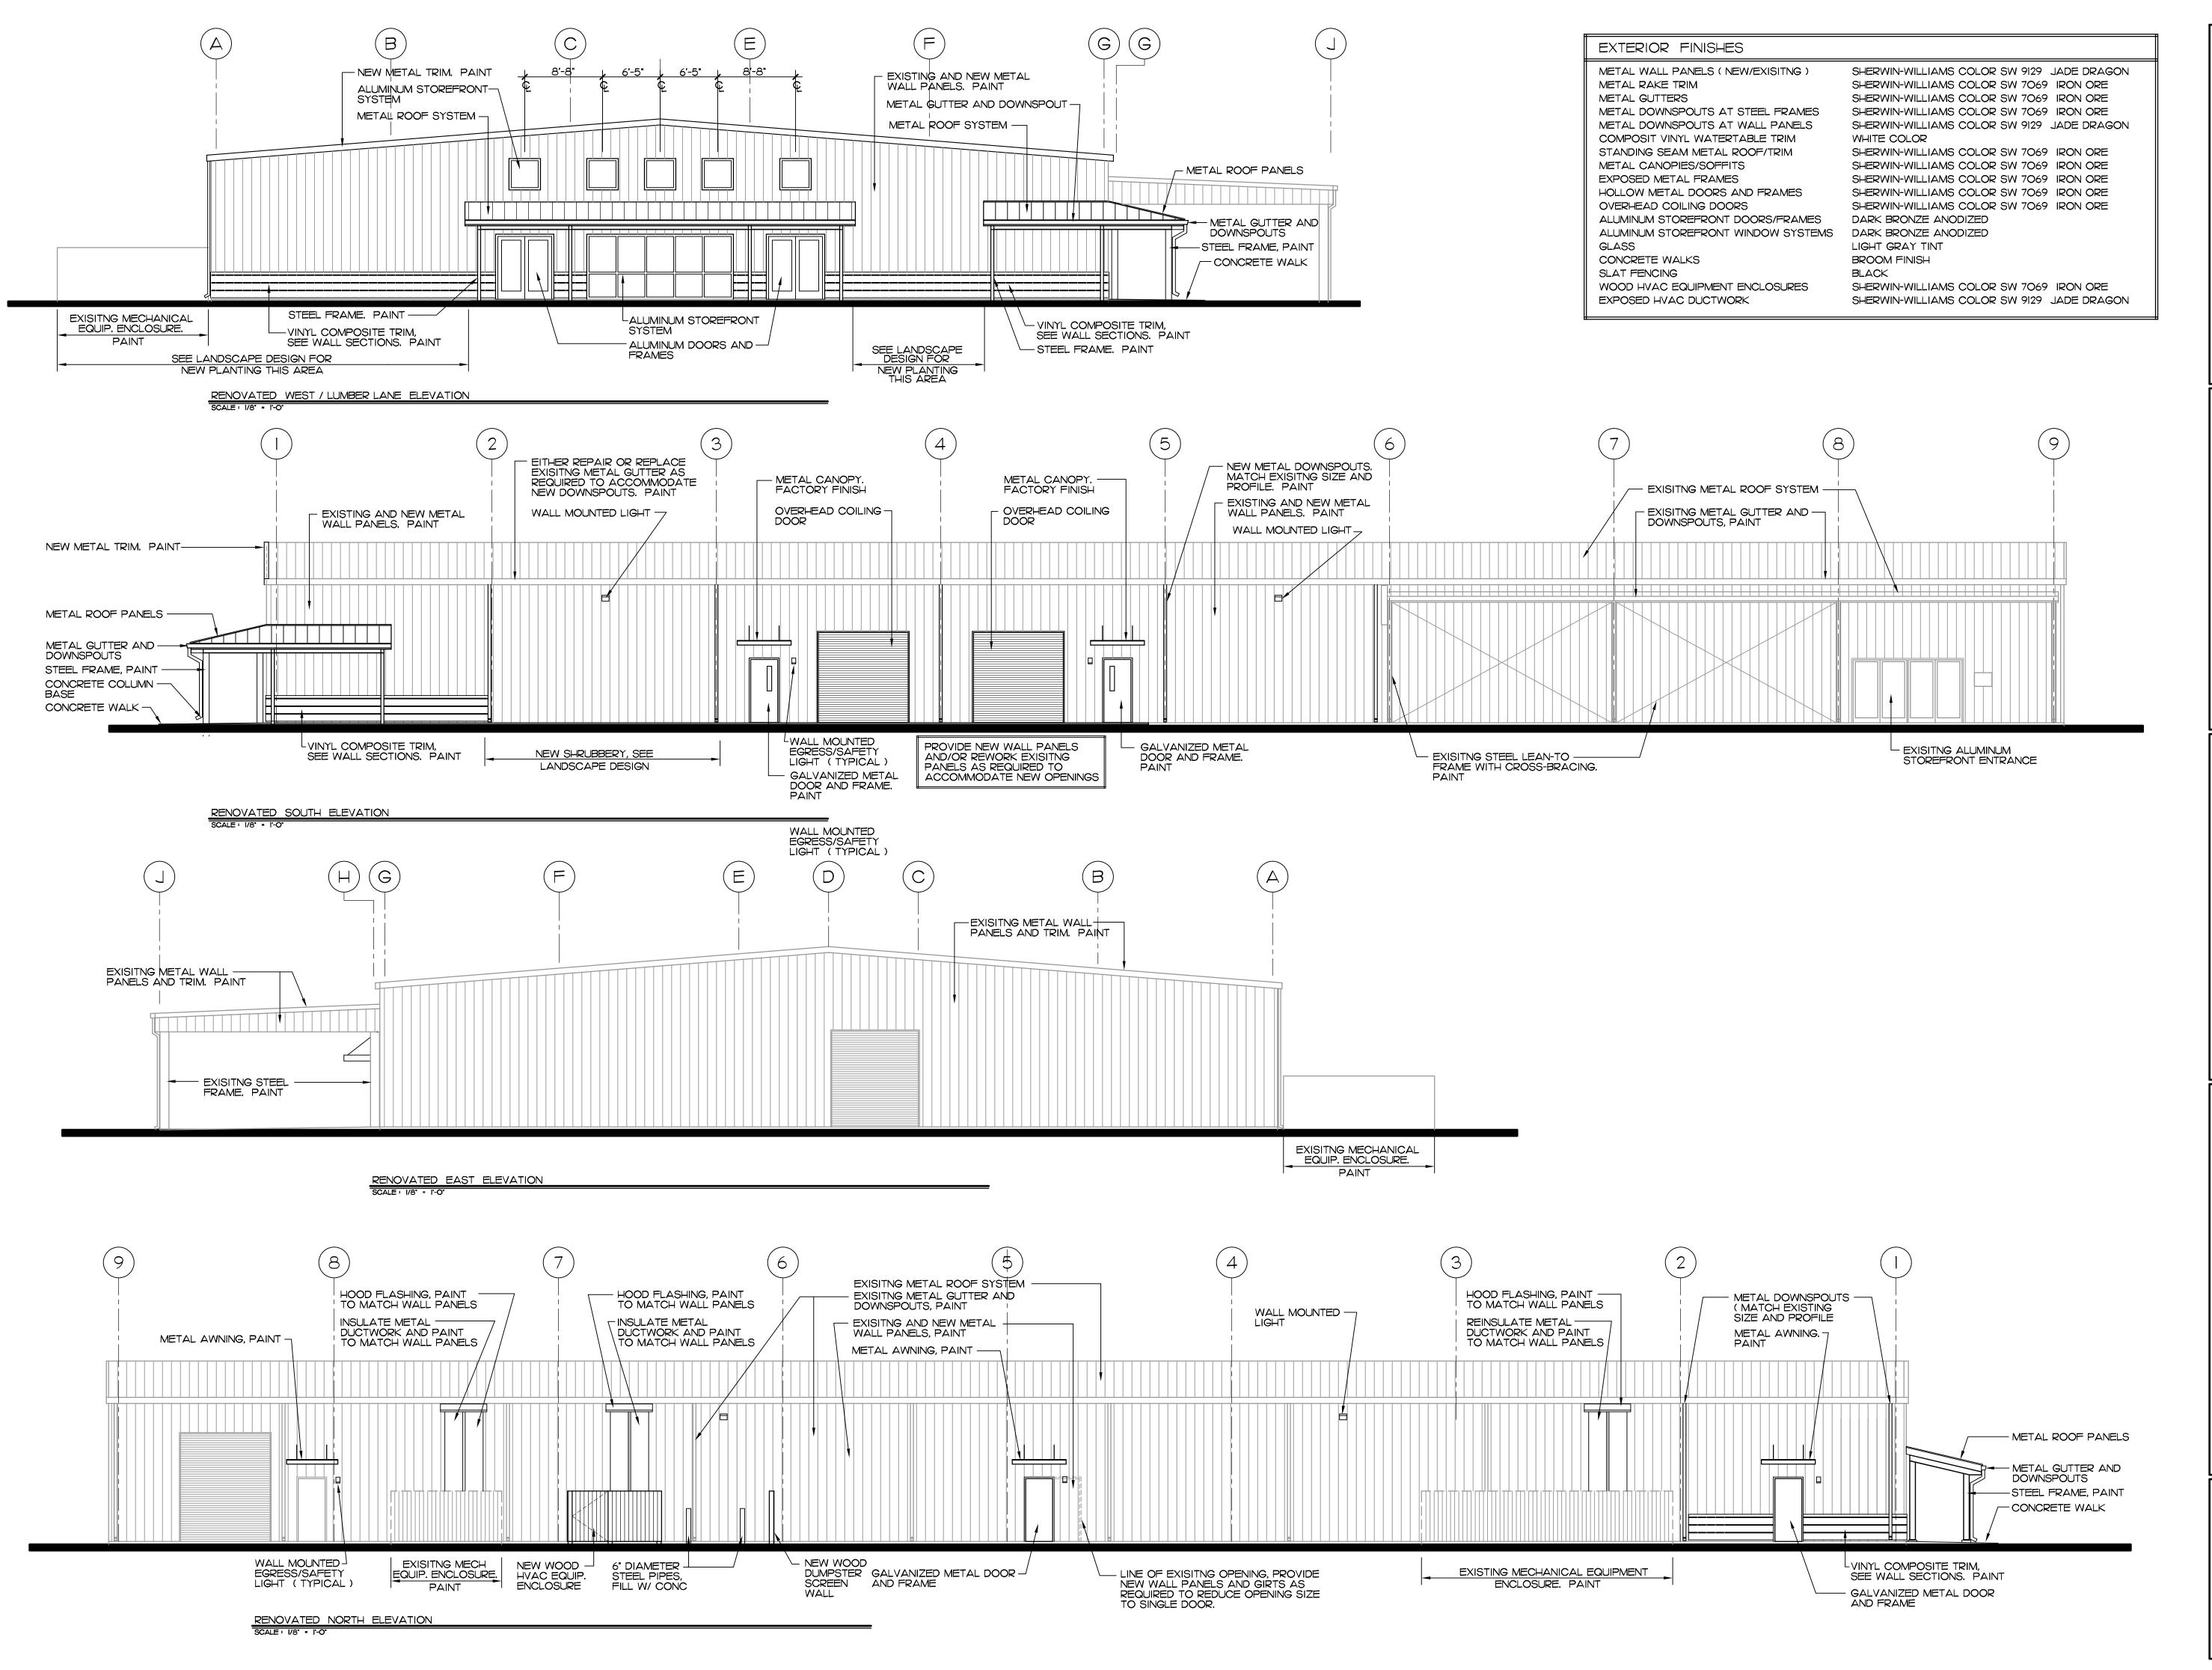

Bell Architects

BELL ARCHITECTS, INC.

SUMMERVILLE, SC

843-884-1185

RENOVATIONS

III LUMBER LANE GOOSE CREEK, SC


FINAL DESIGN

Date • 5-7-18 File No. • 18034

Design : J.E. BELL
Drawn : J.E. BELL
Checked :

No Date Revision

A4

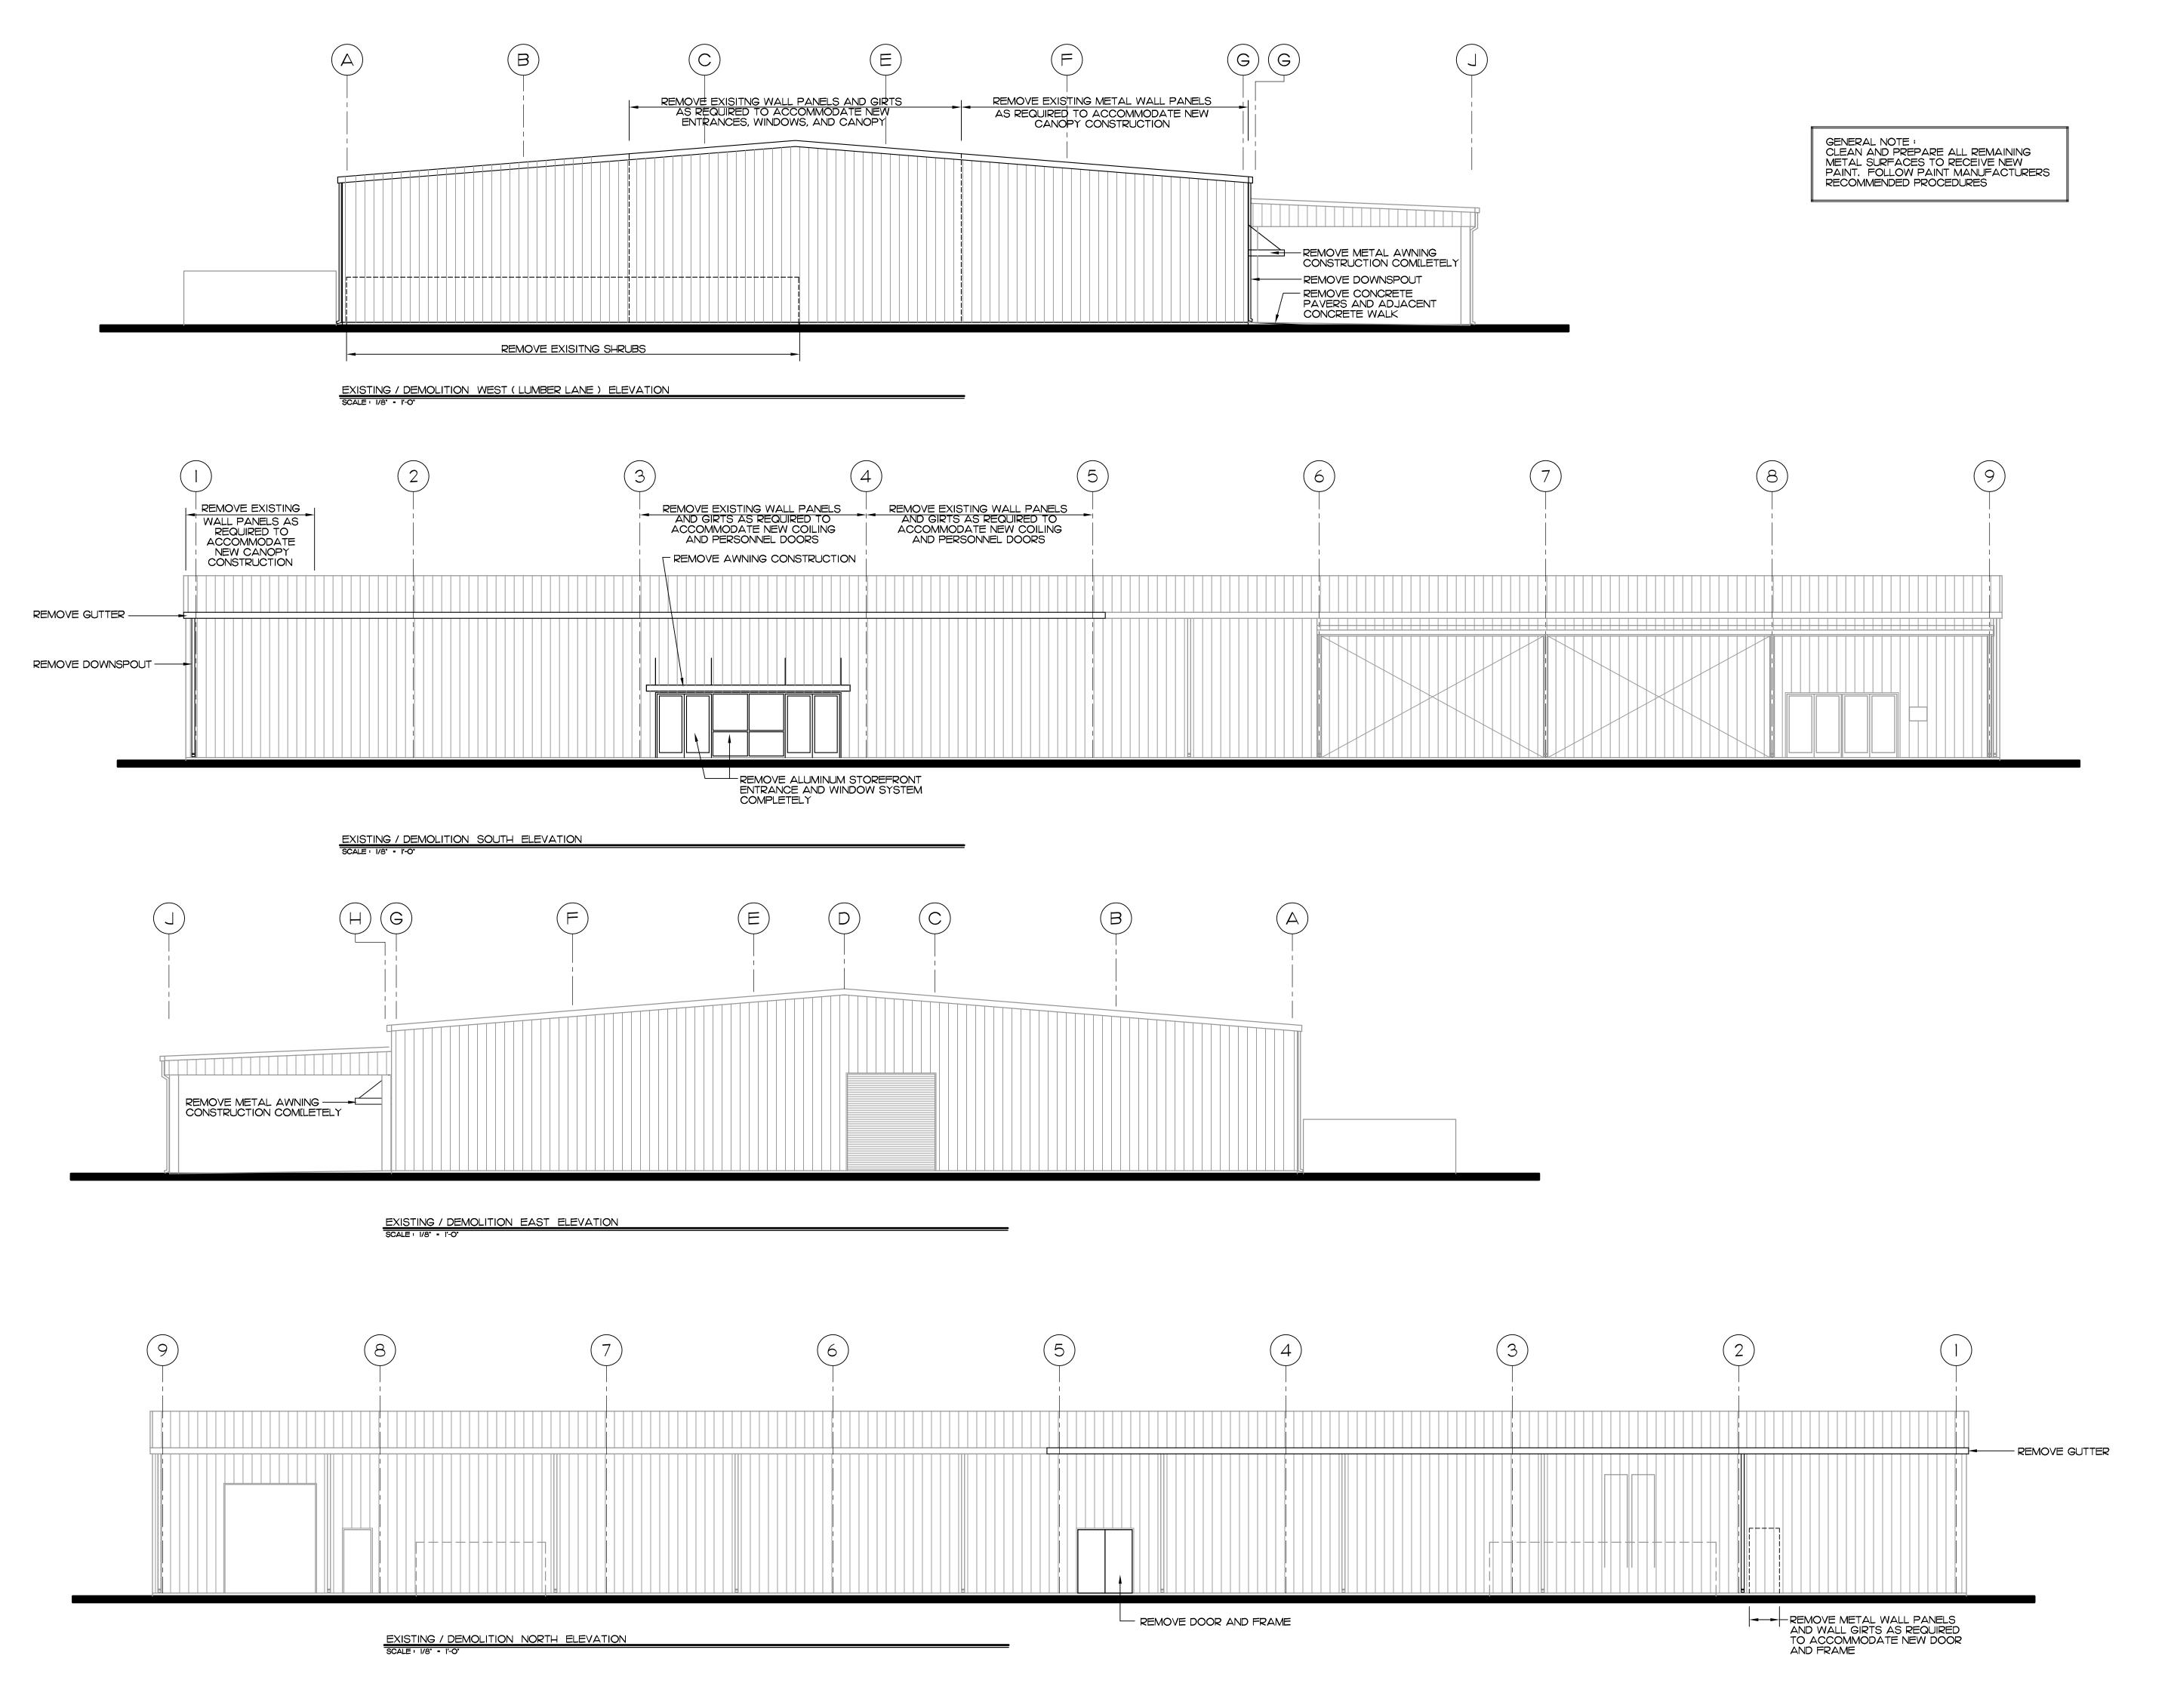

Bell

BELL ARCHITECTS, INC.

SUMMERVILLE, SC

843-884-1185

RENOVATIONS

III LUMBER LANE GOOSE CREEK, SC


FINAL DESIGN

Date : 5-7-18
File No. : 18034

Design : J.E. BELL
Drawn : J.E. BELL
Checked :

No Date | Revision

AL3

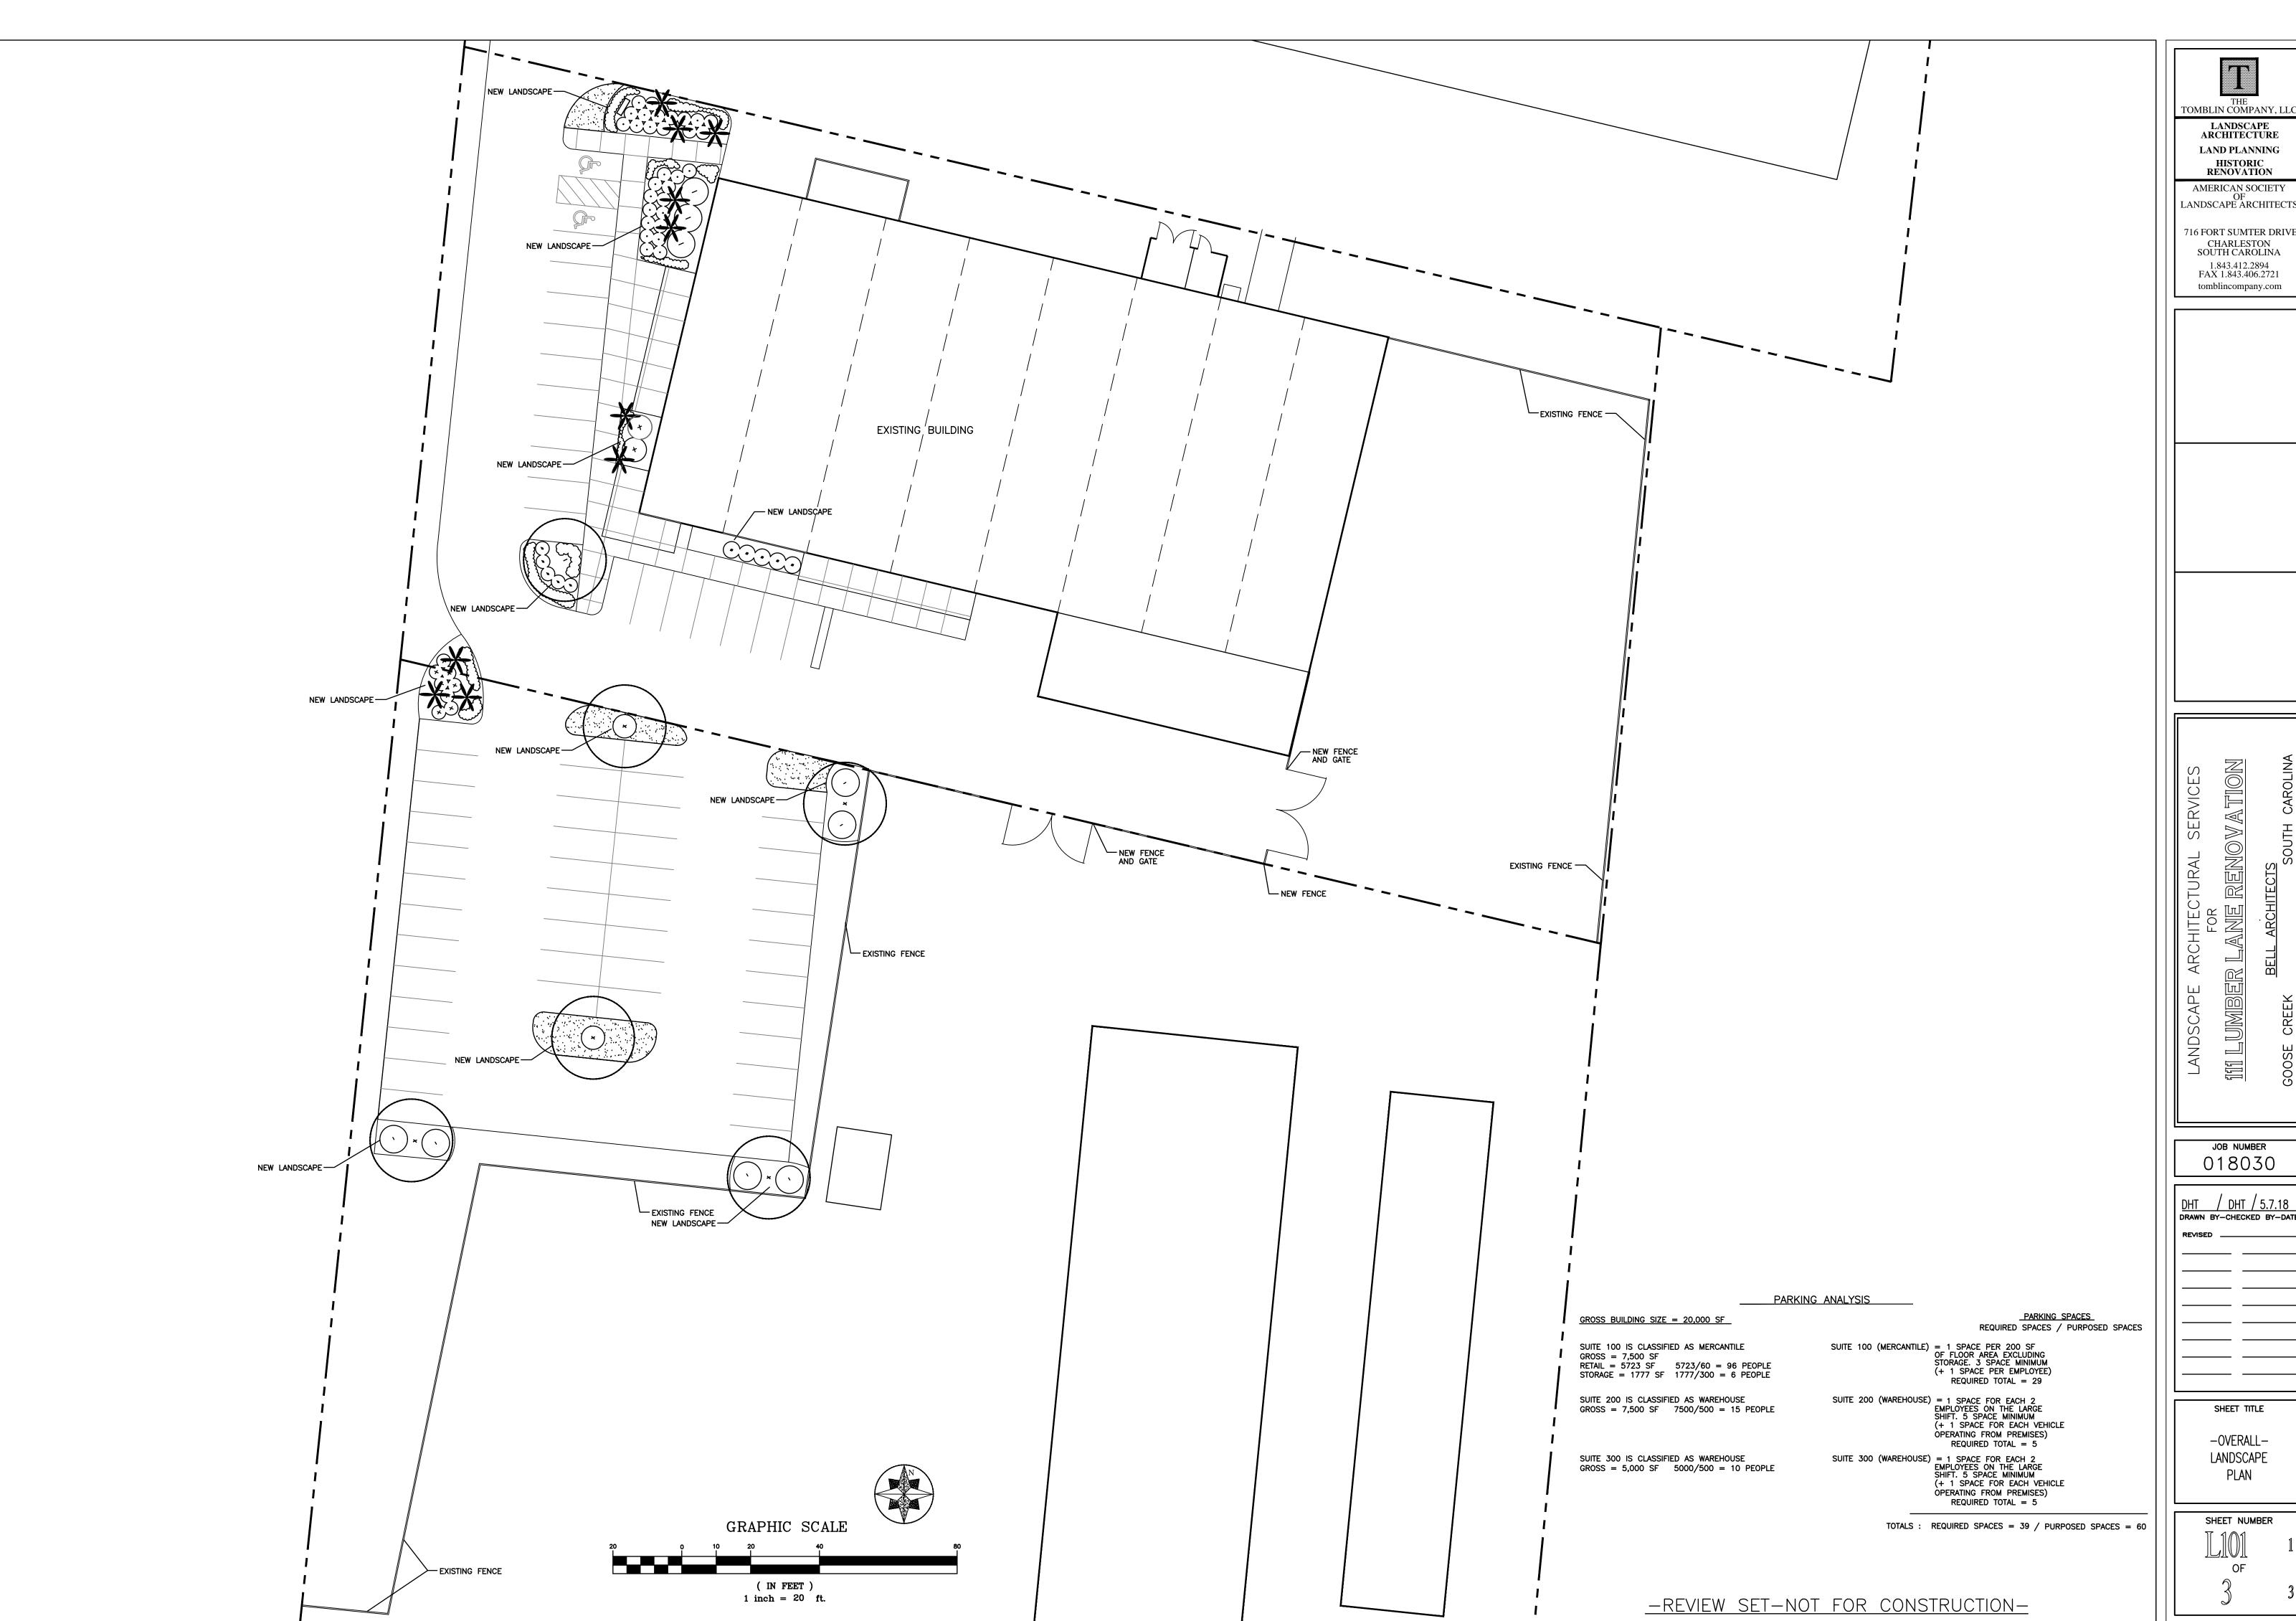

THE TOMBLIN COMPANY, LL LANDSCAPE ARCHITECTURE LAND PLANNING

AMERICAN SOCIETY OF LANDSCAPE ARCHITECTS

CHARLESTON SOUTH CAROLINA 1.843.412.2894 FAX 1.843.406.2721

018030

DHT	/ DHT / 5.7.18
DRAWN	BY-CHECKED BY-DATE
REVISE	·

SHEET NUMBER



Applicant's signature:

Print name legibly:

Brian Cain

Architectural Peview Board

APPLICATION / INFORMATION SUMMARY

DEPARTMENT OF PLANNING AND ZONING 843-797-6220 EXT. 1118


4/27/18

Date:

riopelly Address:	Button Hall Avenue, Goose Creek, SC 2944	TMS No.:	
Review request:	t: For:		ary meeting date requested: May 21, 2018
☐ Conceptual	□New Construction ■Alterations / Additions		eal Decision of Architectural Review Board
□Preliminary X Final	Repairs or repaint with no changes	□Color	Change Demolition
			- Curnette No. 70
, o a part of the state of the	Armored, Inc.		e: (410) 229-1970
Applicant: Brian D), Cain	Daytime phone	e: (410) 229-1970
ARB Meeting Representativ	e:	Contact Inform	nation:
Applicant's mailing address	: 50 Schilling Road		
City: Hunt Valley		State: MD	Zip: 21231
Applicant's e-mail address:	brian.cain@dunbararmored.com		
Applicant's relationship:	Owner Design Professional	Contractor [RealEstate Agent/Broker 🛮 Other
Existing landscaping to	nd fabric to be unfinished galvanized metal remain unchanged. ifixtures to be mounted above overhead door	s and man do	ors.
		tailed decades	NU TO THE RESERVE OF THE PERSON OF THE PERSO
	Scope of Work: (please give a de	tanea aestriptii	on)





105 BUTTON HALL AVENUE GOOSE CREEK, SC 29445

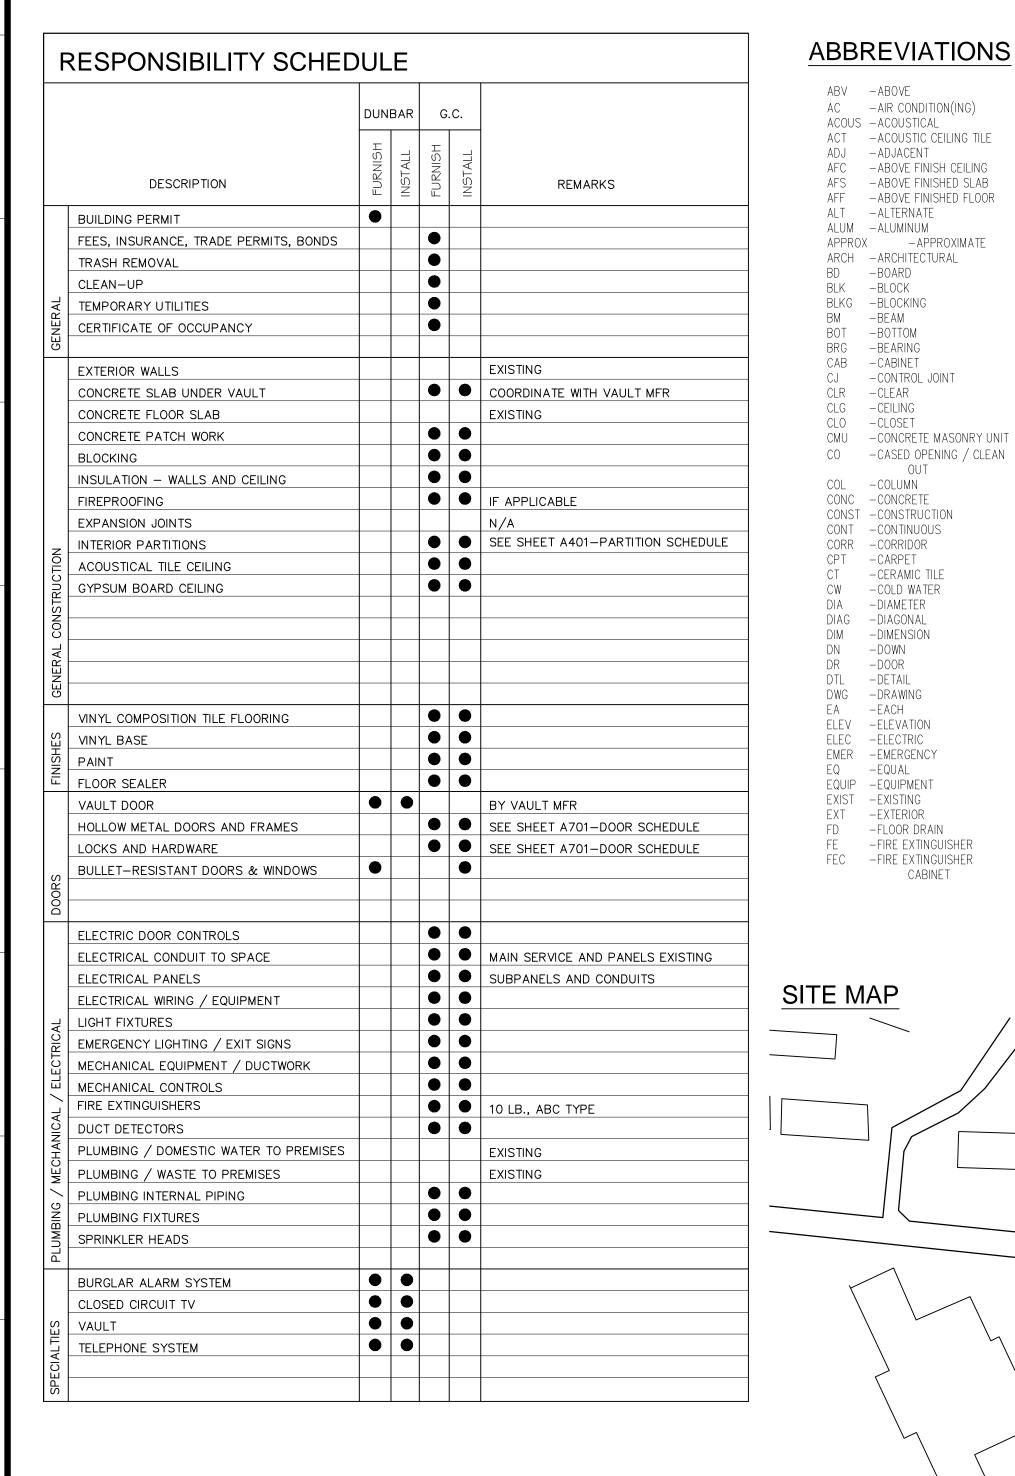

<u>REVIATIONS</u>				
-ABOVE	FIN		OPP	
-AIR CONDITION(ING)	FIXT	-FIXTURE	OH	
-ACOUSTICAL	FLR	-FLOOR	PAF	-POWDER ACTUATED
-ACOUSTIC CEILING TILE	FLUOR	-FLUORESCENT	DI	FASTENER
-ADJACENT	FR	-FRAME/ FIRE RETARDANT	PL	-PLATE
- ABOVE FINISH CEILING	FS FT	-FLOOR SINK	PLAM	-PLASTIC LAMINATE -PLYWOOD
-ABOVE FINISHED SLAB	F I FURR	-FEET -FURRING		-PANEL
-ABOVE FINISHED FLOOR -ALTERNATE	GA	-GAUGE	PNT	-PAINT
- ALUMINUM	GALV	-GALVANIZED		-PAINTED
X — APPROXIMATE	GC	-GENERAL CONTRACTOR		-PARTITION
-ARCHITECTURAL	GL	-GLASS	PVC	-POLYVINYL CHLORIDE
-BOARD			R	-RISER
-BLOCK	GSF	-GRADE -GROSS SQUARE FEET -GYPSUM WALL BOARD -HIGH	RA	-RETURN AIR
-BLOCKING	GWB	-GYPSUM WALL BOARD	RAD	-RADIUS
-BEAM	Н	-HIGH	REFR	-REFRIGERATOR
-BOTTOM	HC	-HOLLOW CORE/	REINF	-REINFORCE(D)
-BEARING		HANDICAPPED	REQ'D	-REQUIRED
-CABINET	HDWD	-HARDWOOD	RM	-ROOM
-CONTROL JOINT	HDWR	-HARDWARE	SC	-SOLID CORE
-CLEAR	HM	-HOLLOW METAL		-SCHEDULE
-CEILING	HORIZ	-HORIZONTAL	SEC	-SECTION
-CLOSET -CONCRETE MASONRY UNIT	HR	-HOUR	SHT	-SHEET
	HT HVAC	-HEIGHT -HEATING, VENTILATION &	SIM SQ	-SIMILAR
-CASED OPENING / CLEAN OUT	ПУАС	AIR CONDITIONING	SQ SS	-SQUARE -STAINLESS STEEL
-COLUMN	HW	-HOT WATER	33 911	-STEEL
-CONCRETE	ID	-INSIDE DIAMETER	STD	-STANDARD
-CONSTRUCTION	INSUL	-INSULATION	STOR	-STORAGE
-CONTINUOUS	JAN	-JANITOR		-STRUCTURAL
-CORRIDOR	JT	-JOINT	SUSP	-SUSPENDED
-CARPET	KDHM	-KNOCK DOWN HOLLOW	SYM	-SYMMETRICAL
-CERAMIC TILE		METAL	TBD	-TO BE DETERMINED
-COLD WATER	LAM	-LAMINATE	TEL	-TELEPHONE
-DIAMETER		-LAVATORY	TEMP	-TEMPERED
-DIAGONAL	LD	-LEASE DIMENSION	TG	-TEMPERED GLASS
-DIMENSION	LT	-LIGHT		-THICK
-DOWN	MAT MAX	-MATERIAL	TOM	-TOP OF MASONRY
-DOOR -DETAIL	MECH	-MAXIMUM -MECHANICAL	TYP	-TYPICAL
-DETAIL -DRAWING	MIN	-MINIMUM	UL	-UNDERWRITER'S
-EACH	MISC	-MISCELLANEOUS	UNO	LABORATORY -UNLESS NOTED OTHERN
-ELEVATION	MO	-MASONRY OPENING	VCT	-VINYL COMPOSITION TIL
-ELECTRIC	MRGB	-MOISTURE RESISTANT	VERT	-VERTICAL
-EMERGENCY		GYPSUM WALLBOARD	VIF	-VERIFY IN FIELD
-EQUAL	MTD	-MOUNTED	W	-WIDE
-EQUIPMENT	MTL	-METAL	WC	-WATER CLOSET
-EXISTING	NC	-NONCOMBUSTIBLE	WD	-WOOD
-EXTERIOR	NIC	-NOT IN CONTRACT	WIN	-WINDOW
-FLOOR DRAIN	NO	-NUMBER	WO	-WINDOW OPENING
-FIRE EXTINGUISHER	NTS	-NOT TO SCALE	WHM	-WELDED HOLLOW METAI
-FIRE EXTINGUISHER	000	-OCCUPANCY	WWF	-WELDED WIRE FABRIC
CABINET	0/0	-ON CENTER		
	OPNG	-OPENING		

BUTTON HALL AVE

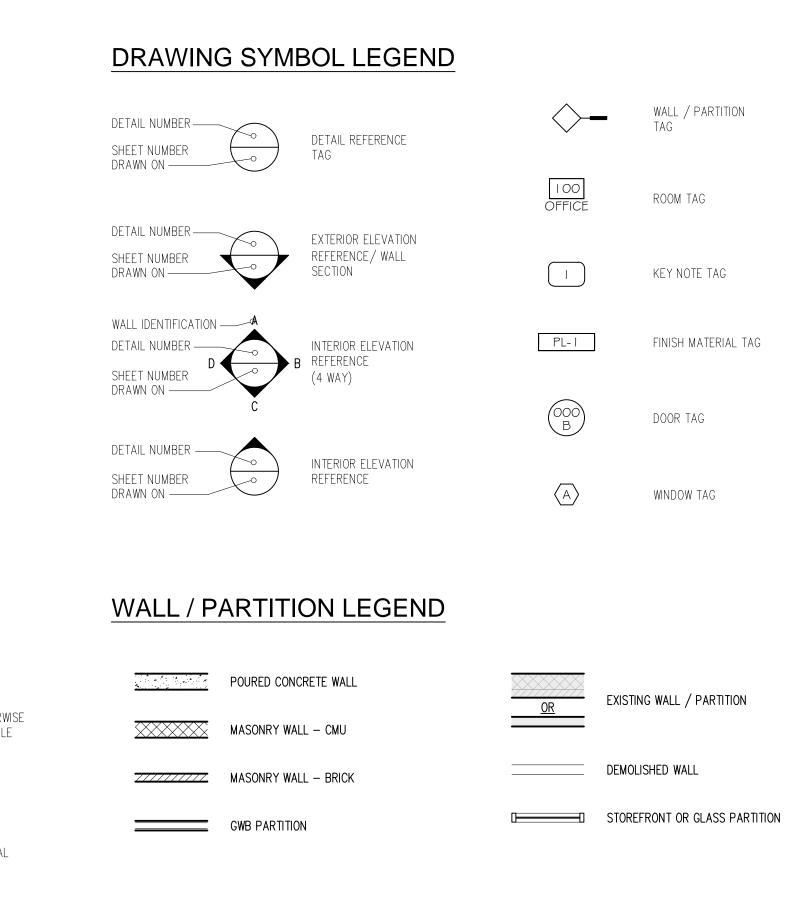

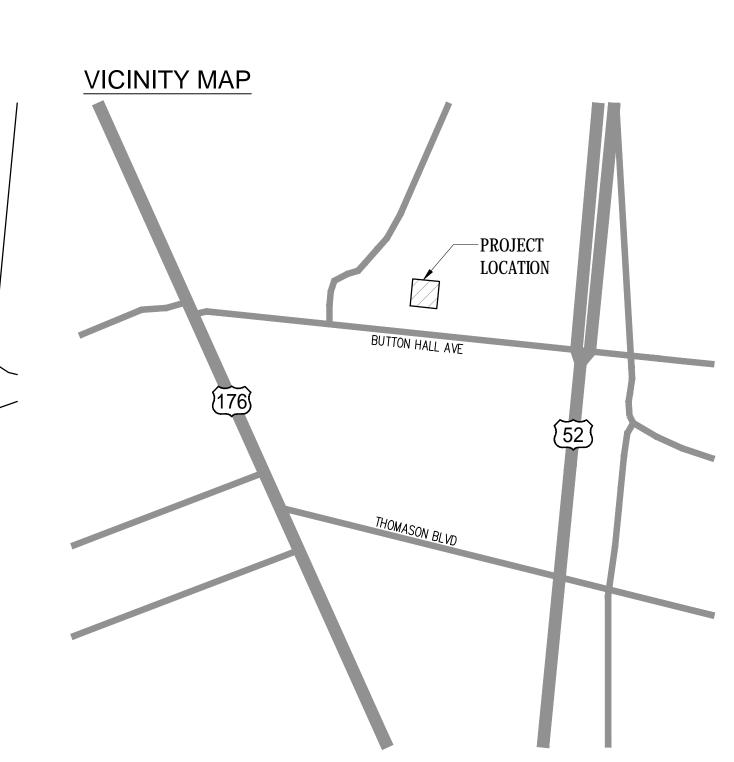

DRAWING SHEET INDEX

SHEET No. SHEET TITLE

ARCHITECTURAL

G-001 PROJECT INFORMATION
G-101 BUILDING CODE ANALYSIS AND LIFE SAFETY FLOOR PLAN
G-201 GENERAL NOTES, CONTRACTOR NOTES, AND SPECIFICATIONS
D-101 DEMOLITION FLOOR PLAN
A-101 NEW WORK FLOOR PLAN
A-102 REFLECTED CEILING PLAN
A-201 DETAIL PLANS AND INTERIOR ELEVATIONS
A-202 TOILET ROOM PLANS, ELEVATIONS, AND SCHEDULE
A-301 VAULT DETAILS
A-401 PARTITION SCHEDULE
A-501 DETAILS
A-701 DOOR AND HARDWARE SCHEDULE
A-702 WINDOW AND FINISH SCHEDULE

S-101 STRUCTURAL PLAN & NOTES

MECHANICAL
M-101 MECHANICAL PLAN
M-201 MECHANICAL SCHEDULES
M-301 MECHANICAL DETAILS
MP-101 MECHANICAL PLUMBING SPECIFICATIONS
MP-102 MECHANICAL PLUMBING SPECIFICATIONS

PLUMBING

P-101 OVERALL & ENLARGED PLUMBING PLANS
P-201 PLUMBING SCHEDULES & RISERS
P-301 PLUMBING DETAILS

ELECTRICAL

E-101 LIGHTING PLAN
E-102 LIGHTING DETAILS
E-201 POWER PLAN
E-202 POWER DETAILS
E-301 SYSTEMS PLAN
E-302 ELECTRICAL DETAILS
E-401 PANEL SCHEDULES
E-402 ONE-LINE DIAGRAM
E-501 ELECTRICAL SPECIFICATIONS

PROJECT DIRECTORY

PROJECT NAME/ADDRESS:
DUNBAR ARMORED, INC.
6066 AVIATOR DRIVE
HAZLETON, MO 63042

DUNBAR ARMORED, INC.
50 SCHILLING RD.
HUNT VALLEY, MARYLAND 21031
CONTACT: BRIAN D. CAIN, VICE PRESIDENT OF FACILITIES
TELEPHONE: 410-229-1970
FACSIMILE: 410-229-1971

E-MAIL: BRIAN.CAIN@DUNBARARMORED.COM

JURISDICTIONAL AUTHORITY
THE CITY OF GOOSE CREEK
519 N. GOOSE CREEK BOULEVARD
GOOSE CREEK, SC 29445
CONTACT: RENEE PHILLIPS
TELEPHONE: (843) 797-6220 X1100
FACSIMILE: (843) 863-5208
E-MAIL: RPHILLIPS@CITY OFGOOSECREEK.COM

ARCHITECT OF RECORD:

L2M, INC.
811 CROMWELL PARK DRIVE, SUITE 113
GLEN BURNIE, MD 21061
CONTACT: JEFREY MAHLER
TELEPHONE: (410) 863-1302 X115
FACSIMILE: (410) 863-1308
E-MAIL: JMAHLER@L2M.COM

STRUCTURAL ENGINEER:
BLUESTREAK CONSULTING ENGINEERS
25001 EMERY ROAD, SUITE 400
CLEVELAND, OH 44128
CONTACT: TERRY FRANCIS
TELEPHONE: (216) 223-3296
FACSIMILE: (216) 223-3210
E-MAIL: TFRANCIS@BLUESTREAK-CONSULTING.COM

MEP ENGINEER:
BLUESTREAK CONSULTING ENGINEERS
25001 EMERY ROAD, SUITE 400
CLEVELAND, OH 44128
CONTACT: PETER FITZGERALD

TELEPHONE: (216) 223–3290

FACSIMILE: (216) 223–3210

E-MAIL: PFITZGERALD@BLUESTREAK-CONSULTING.COM

17.300 SHEET #

FILE NAME: 17.300 -G-001 .dwg

L2M
811 Cromwell Park Drive, Suite 113
Cromwell Business Park at BWI
Glen Burnie, Maryland 21061

L2M@L2M.com
Phone 410.863.1302
Fax 410.863.1308

ARCHITECT OF RECORD:

ARCHITECTS

Dunkar ARMORED

50 SCHILLING ROAD HUNT VALLEY, MD 21031

CHARLESTON
N HALL AVENUE
REEK, SC 29445

JUNBAK - CHA 105 BUTTON HALL GOOSE CREEK, §

REV. #	ISSUE / DESCRIPTION	DATE
	ISSUED FOR PERMIT	04/11/2018


DRAWING DATE:
04/11/2018

DRAWN BY: REVIEWED BY:
JAB TPF/SL

PROJECT

INFORMATION

G-001

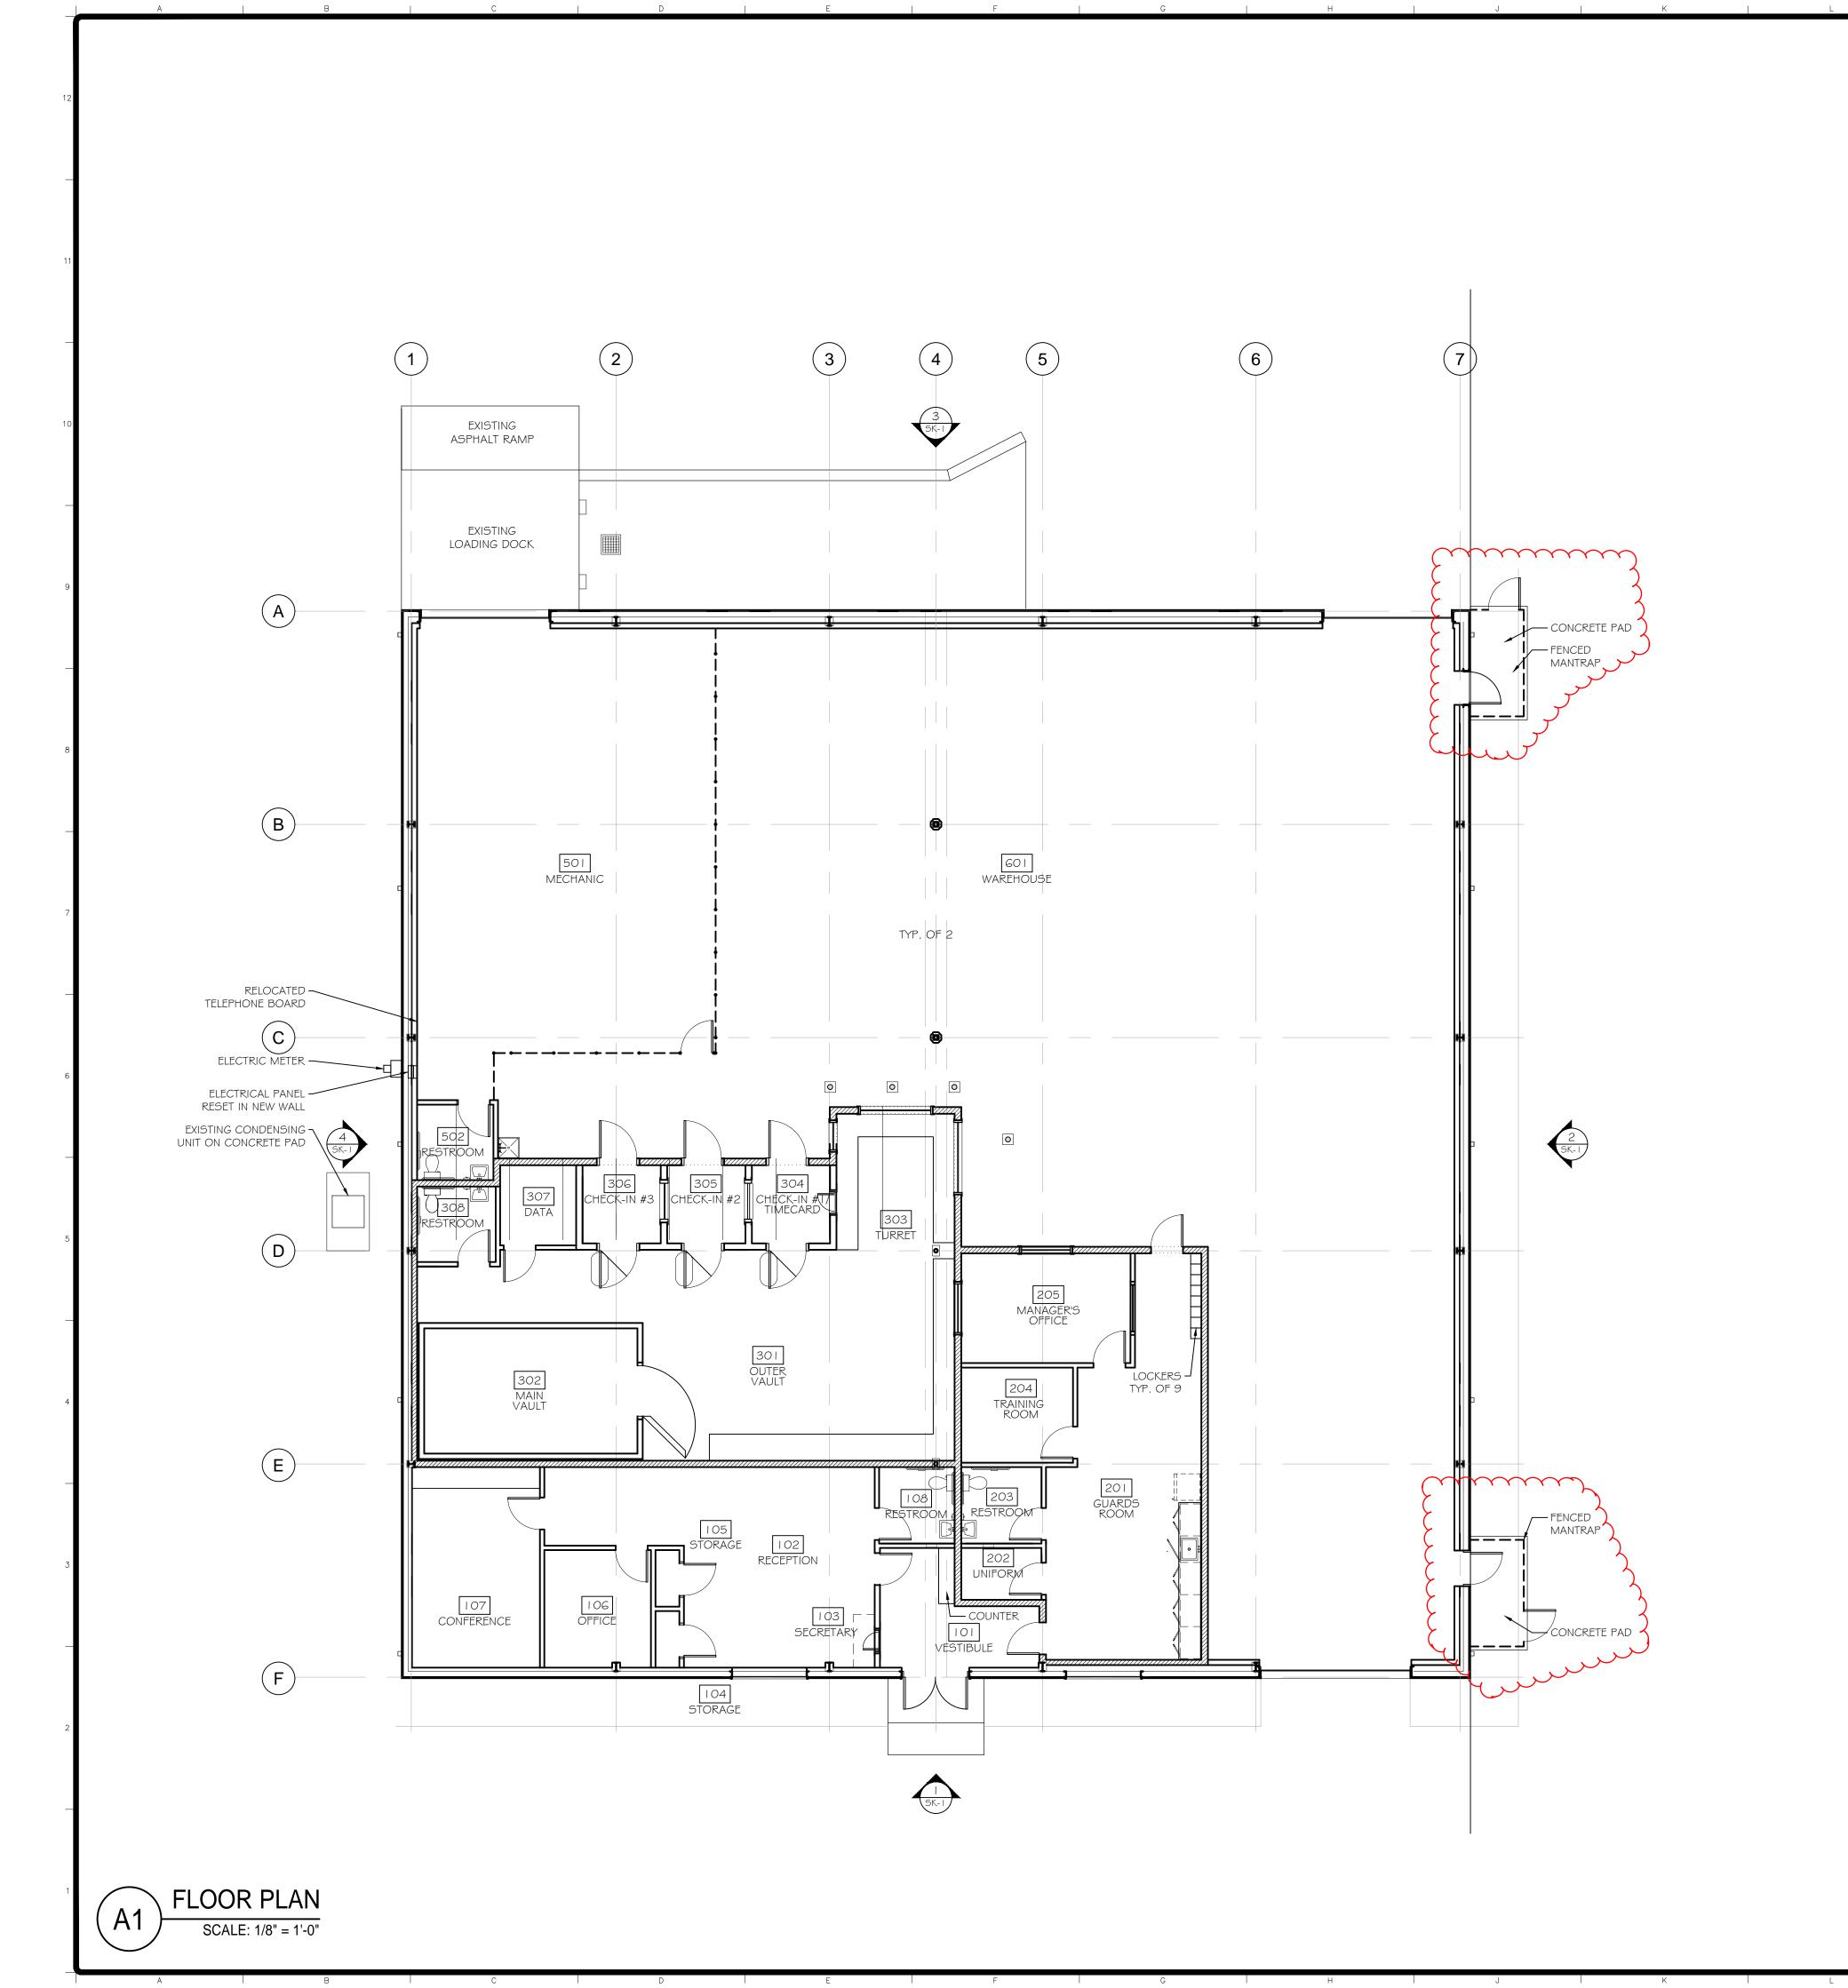

FLOOR PLAN NOTES:

- 1. SEE SHEET A-401 FOR PARTITION SCHEDULE.
- 2. SEE SHEET A-701 FOR DOOR AND DOOR HARDWARE SCHEDULES.
- 3. SEE SHEET A-702 FOR FINISH AND WINDOW SCHEDULES.
- 4. SEE SHEETS A-201 AND A-202 FOR PARTITION TAGS AT RESTROOMS AND CHECK-IN ROOMS.
- 5. SEE SHEET A-301 FOR PARTITION TYPES ADJACENT TO VAULTS.



811 Cromwell Park Drive, Suite 113 Cromwell Business Park at BWI Glen Burnie, Maryland 21061 L2M@L2M.com 410.863.1302 410.863.1308

ARCHITECT OF RECORD:

L2MARCHITECTS

ARMORED

50 SCHILLING ROAD HUNT VALLEY, MD 21031

VENUE 29445 105 BUTTON HALL A GOOSE CREEK, SC


REV. # ISSUE / DESCRIPTION DATE ISSUED FOR PERMIT 04/11/2018

FLOOR PLAN

DRAWING DATE: 04/11/2018 DRAWN BY: REVIEWED BY: TPF/SL

PROJECT # **17.300**

FILE NAME: 17.300 - A-101 .dwg

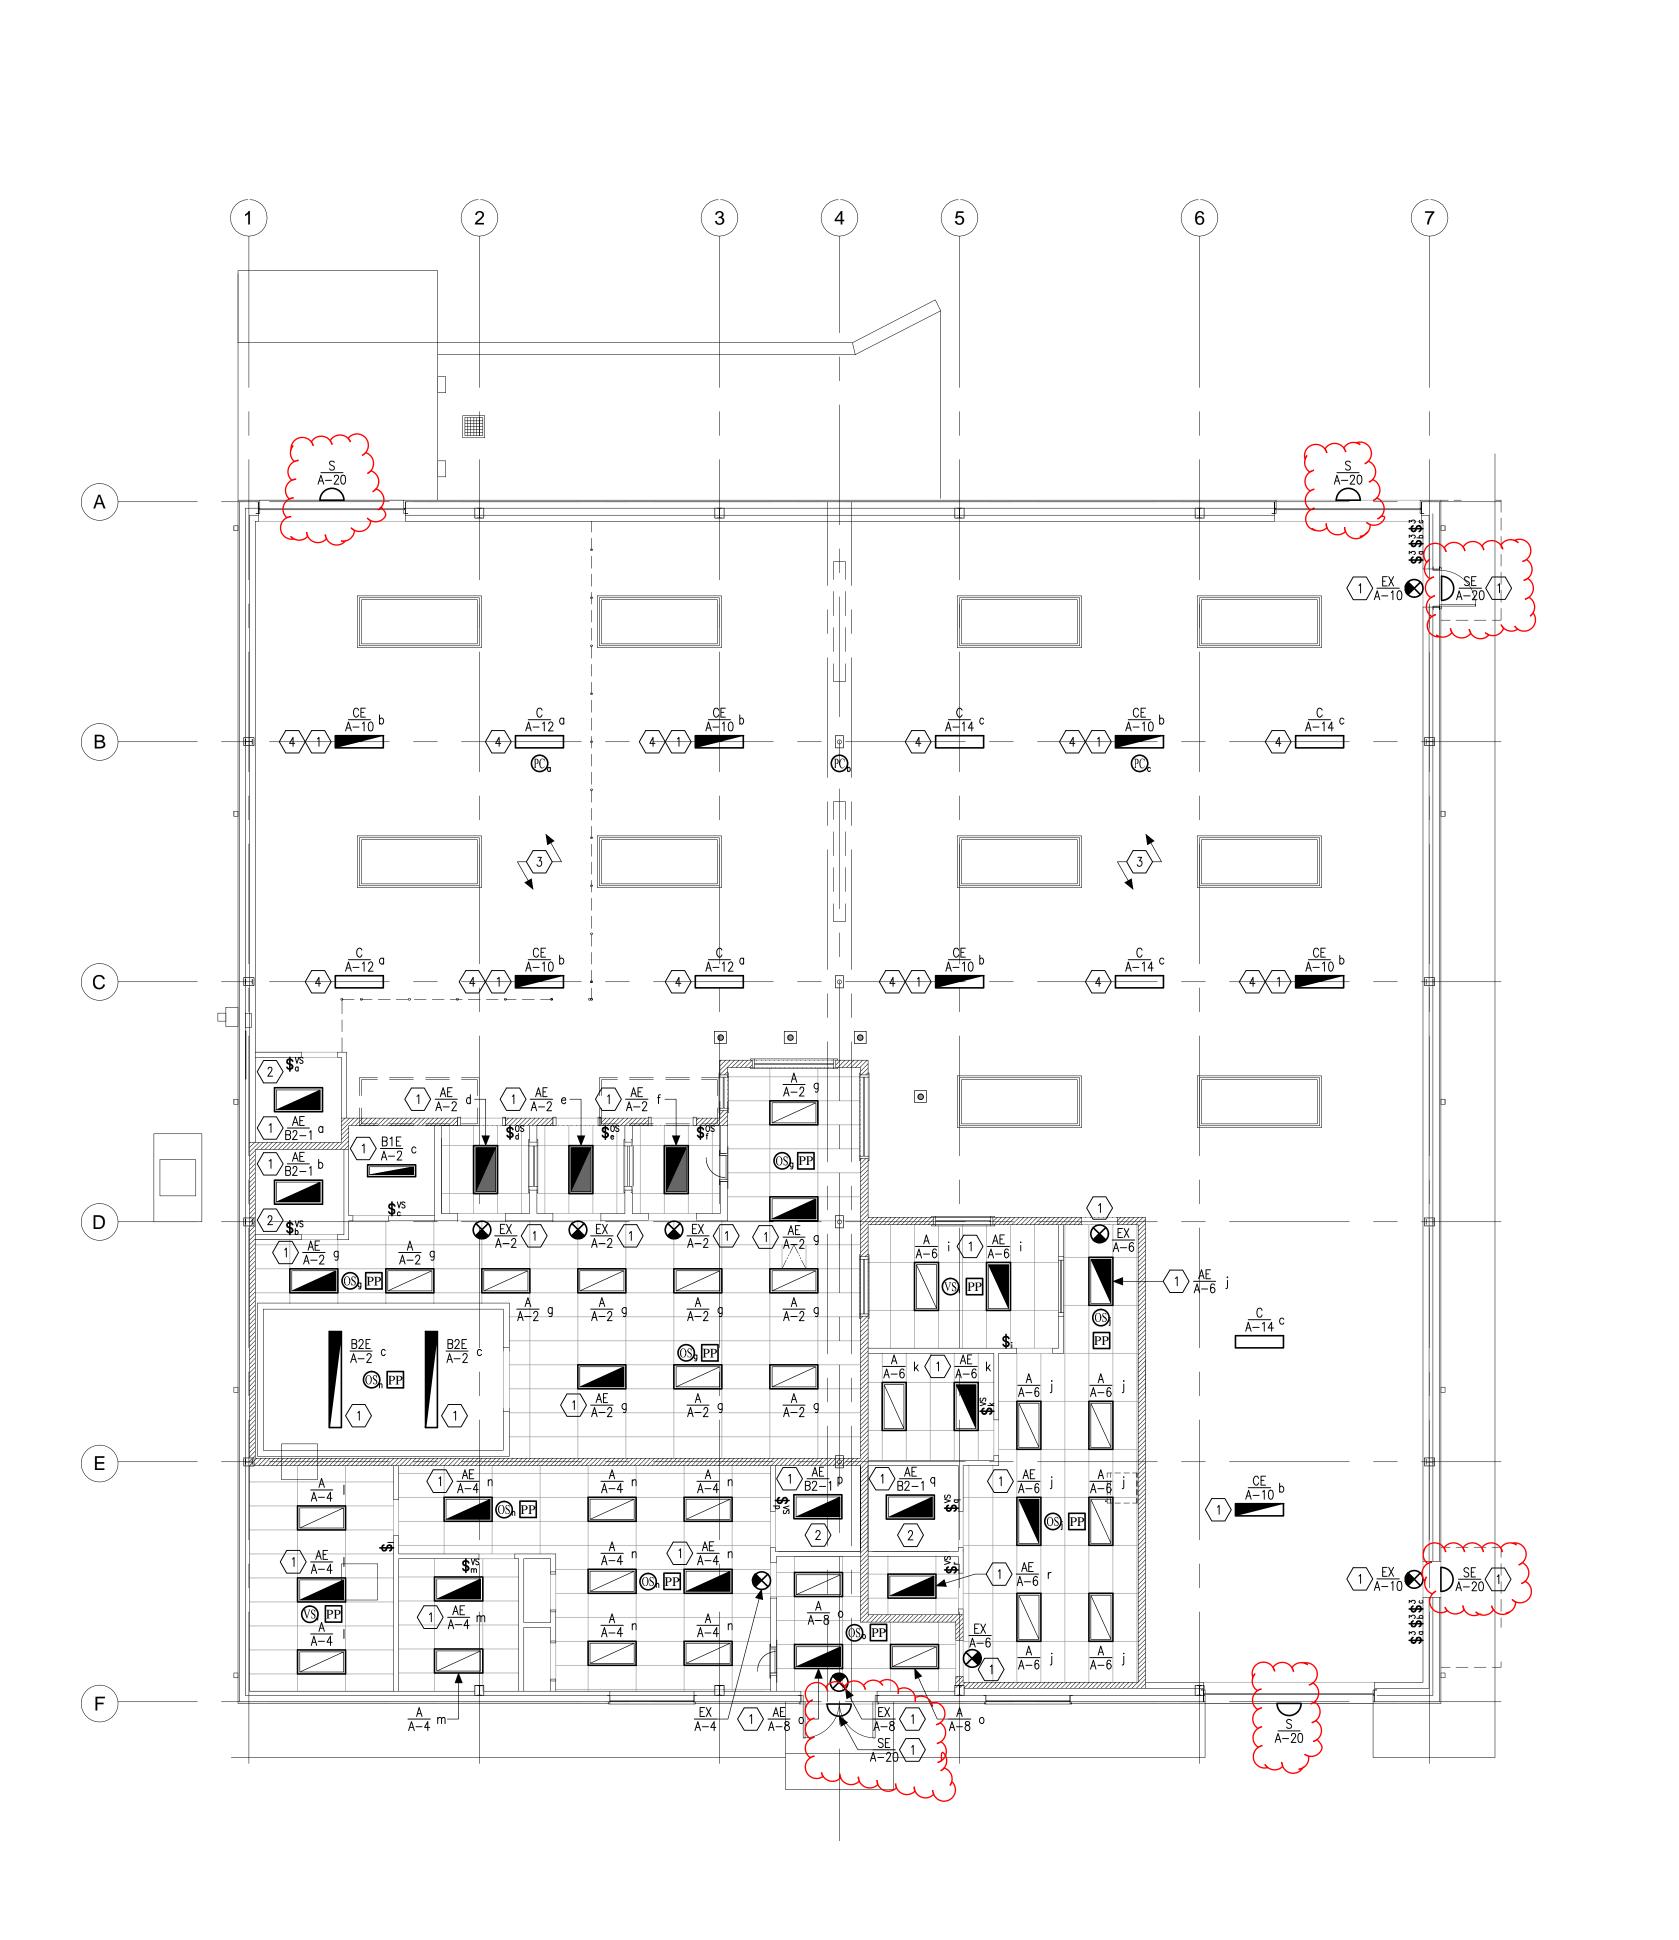

GENERAL NOTES:

- ALL DEVICES, EQUIPMENT, FIXTURES, ETC. MUST BE GROUNDED BY USE
 OF A PROPERLY SIZED GROUNDING CONDUCTOR.
 MECHANICAL/ELECTRICAL BONDS OF THE METALLIC RACEWAY SYSTEM
 SHALL ALSO BE MAINTAINED.
- 2. BRANCH CIRCUIT WIRE SIZES (AND CONDUITS) SHALL BE INCREASED FROM THOSE INDICATED ON THE PLANS TO PREVENT EXCESSIVE VOLTAGE DROP. BRANCH CIRCUITS SHALL BE INSTALLED WITH WIRES OF SUFFICIENT SIZE SO THAT VOLTAGE DROP BETWEEN THE PANEL AND THE LOADS DOES NOT EXCEED A LIMIT OF 3%.
- 3. CIRCUITS MAY BE COMBINED IN CONDUIT PROVIDED WIRE IS PROPERLY DERATED AND CONDUIT SIZED PER CODE. UNDER NO CIRCUMSTANCES SHALL MORE THAN NINE (9) CURRENT CARRYING CONDUCTORS BE RUN IN A SINGLE CONDUIT.
- 4. ALL CONDUITS SHALL CONTAIN A GROUND WIRE SIZED PER NEC TABLE #250-122. WHERE CIRCUIT CONDUCTORS ARE INCREASED IN SIZE FOR VOLTAGE DROP, THE GROUND WIRE SIZE SHALL BE INCREASED PROPORTIONATELY (ACCORDING TO CIRCULAR MIL AREA) FROM THE SIZE REQUIRED BY NEC TABLE #250-122.
- 5. EXPOSED CONDUITS, WHERE PERMITTED, SHALL BE RUN PARALLEL TO OR AT RIGHT ANGLES TO BUILDING STRUCTURAL MEMBERS.

XKEYED NOTE SCHEDULE

- 1. PROVIDE CONSTANT HOT AROUND ALL CONTROLS FOR PROPER OPERATION OF EMERGENCY LIGHTING/EXIT SIGNS. NORMAL BALLAST CONTROLLED AS SHOWN.
- 2. RESTROOM EXHAUST FANS SHALL BE CONTROLLED WITH RESTROOM LIGHTING VIA LOCAL CONTROLS.
- 3. MECHANIC AND LOADING AREA LIGHTING SHALL BE CONTROLLED THROUGH TIMECLOCK PROGRAMMED TO OPERATE PER OWNER'S REQUIREMENTS. PROVIDE MANUAL OVERRIDE AT LOCATION DIRECTED BY OWNER
- 4. ROUTE LIGHTING CIRCUIT THROUGH PHOTOCELL FOR DAYLIGHT HARVESTING AS REQUIRED BY ENERGY CODE.

DEMOLITION NOTES:

- 1. PERFORM ALL DEMOLITION OF EXISTING ELECTRICAL SYSTEMS AS INDICATED ON ELECTRICAL AND ARCHITECTURAL PLANS OR NECESSARY FOR THE PROJECT. REMOVE FROM SITE AND PROPERLY DISPOSE OF ALL MATERIAL AND DEBRIS FROM THIS WORK.
- 2. DEMOLITION DRAWINGS ARE GENERAL IN NATURE SHOWING THE SCOPE OF DEMOLITION WORK. CONTRACTOR SHALL VISIT THE SITE AND BECOME FAMILIAR WITH THE QUANTITY OF LIGHT FIXTURES, OUTLETS, ETC. REMOVE ALL EQUIPMENT AND DEVICES NO LONGER REQUIRED FOR FINISHED CONSTRUCTION. REMOVE CONDUITS BEYOND NEW SURFACES. REMOVE ALL EXISTING WIRE FROM CONDUIT BACK TO POINT OF COMMON USE OR TO PANELS.
- REMOVE AND/OR RELOCATE EXISTING ELECTRICAL DEVICES ON WALLS OR CEILING BEING REMOVED. COORDINATE EXACT CONDITIONS WITH ARCHITECTURAL DRAWINGS.
- 4. FOR ALL DEVICES AND FIXTURES BEING REMOVED, REMOVE RELATED CONDUIT AND WIRING TO SOURCE. RE-LABEL EXISTING CIRCUIT BREAKERS AS "SPARE" WHEN LOAD IS COMPLETELY REMOVED OR REVISE LABEL ON PANEL DIRECTORY APPROPRIATELY.
- 5. PATCH ALL SURFACES TO MATCH SURROUNDING FOR DEVICES TO BE REMOVED FROM EXISTING WALL TO BE MAINTAINED. ALL CIRCUITS WHICH ARE REQUIRED TO REMAIN ACTIVE SHALL BE MAINTAINED OR REWORKED AS REQUIRED. ANY EXISTING CIRCUITS OR CABLING SYSTEMS SERVING AREAS NOT AFFECTED BY DEMOLITION SHALL BE MAINTAINED.
- 6. ALL CIRCUITS SHALL BE VERIFIED WITH EXISTING DRAWINGS AND ACTUAL FIELD CONDITIONS PRIOR TO BEGINNING DEMOLITION
- 7. EXISTING LIGHT FIXTURES BEING RELOCATED SHALL BE CLEANED AND RE-LAMPED. VERIFY CORRECT OPERATION OF EXISTING FIXTURE AND REPORT ALL FAULTY CONDITIONS TO THE ARCHITECT OR OWNER.
- 8. THE OWNER RESERVES THE RIGHT OF SALVAGE FOR ALL EXISTING ELECTRICAL EQUIPMENT PRIOR TO DEMOLITION. THE CONTRACTOR SHALL REVIEW ALL MATERIALS AND DELIVER TO THE OWNER THOSE REQUIRED IN THEIR EXISTING CONDITION. ALL OTHER MATERIAL SHALL BE REMOVED BY THIS CONTRACTOR.
- 9. REMOVE DATA AND PHONE CABLING SYSTEM AS DIRECTED BY OWNER. NO CABLES SHALL BE REMOVED OR CUT WITHOUT APPROVAL FROM OWNER. ANY EXISTING CABLES TO REMAIN SHALL BE SUPPORTED FROM STRUCTURE BEFORE CEILING REMOVAL.

22

L2M 811 Cromwell Park Drive, Suite 1 Cromwell Business Park at BWI Glen Burnie, Maryland 21061 L2M@L2M.com



BLUESTREAK CONSULTING 25001 EMERY ROAD, SUITE 400

CLEVELAND, OH 44128 TEL (216) 223-3200 FAX (216) 223-3210

ARMORED

50 SCHILLING ROAD HUNT VALLEY, MARYLAND 21031

ALL AVENUE K, SC 29445

JNBAK - CHAKL 105 BUTTON HALL AV GOOSE CREEK, SC 2

REV. # ISSUE / DESCRIPTION DATE

ISSUED FOR PERMIT 04/11/2018

SHEET TITLE:

LIGHTING PLAN


DRAWING DATE:
03-31-2018
DRAWN BY: REVIEWED BY:
PROJECT #

E-101

FILE NAME: 16415 - E-101 .dwg


01) LIGHTING PLAN

SCALE: 1/8" = 1'-0"

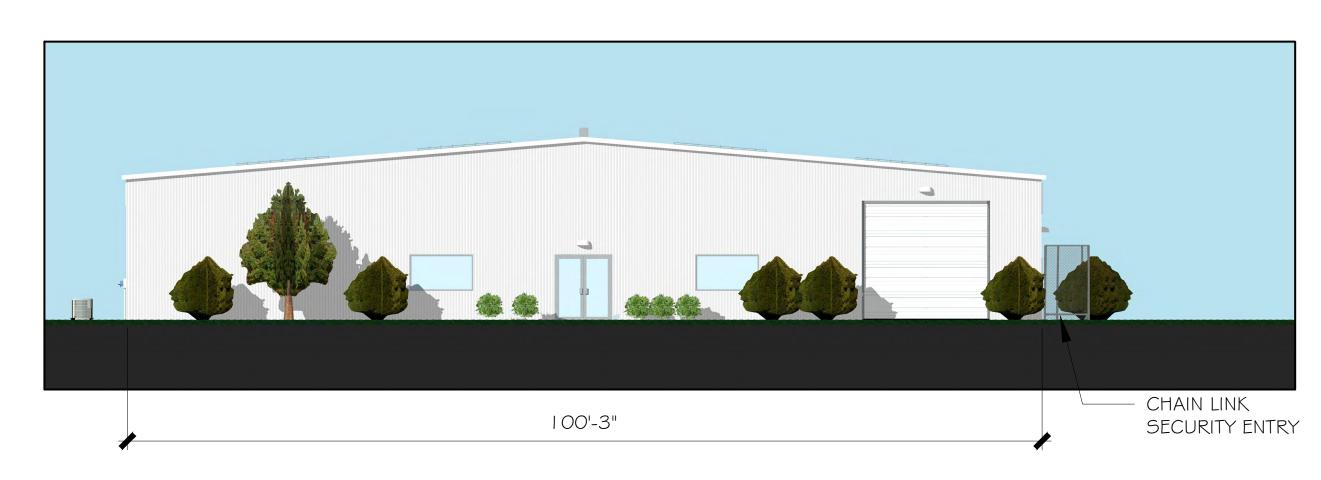


SOUTH (STREET) ELEVATION

SCALE: 3/32" = 1'-0"

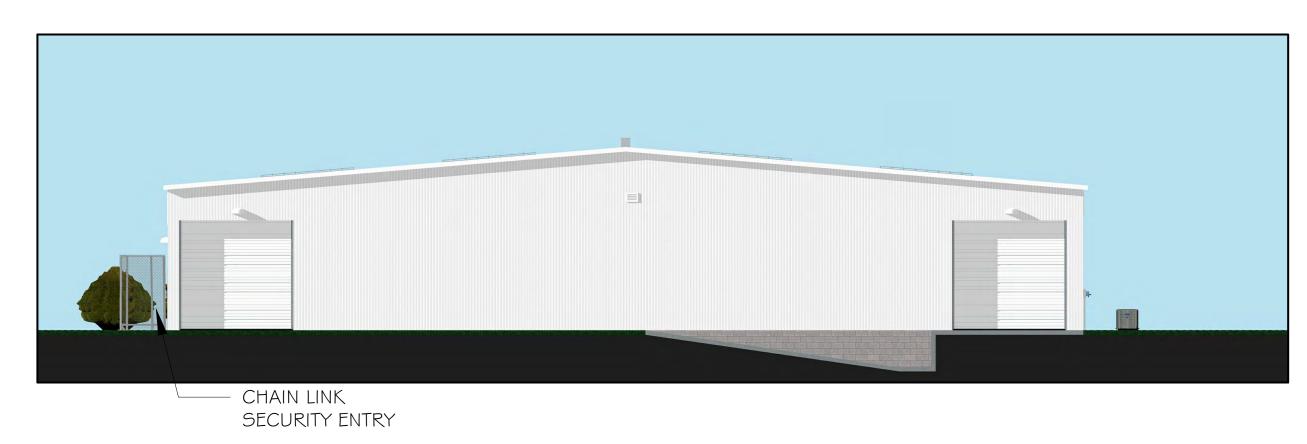


NORTH ELEVATION

SCALE: 3/32" = 1'-0"

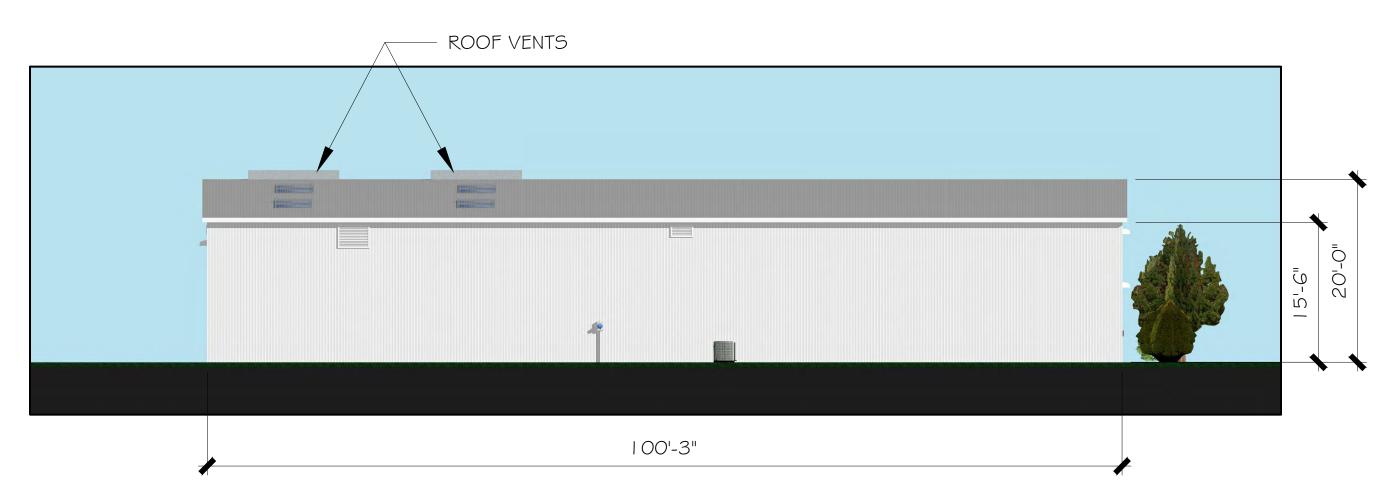

WEST ELEVATION

SCALE: 3/32" = 1'-0"

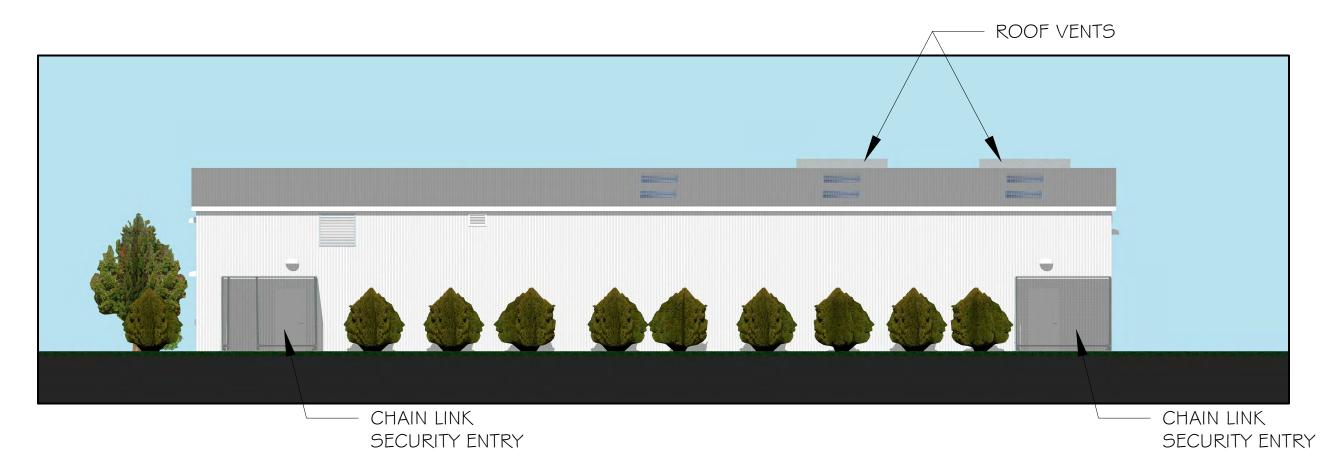

EAST ELEVATION

SCALE: 3/32" = 1'-0"

Standard Colors

Disclaimer: This color chart is for reference only and is not to be used for final color matching. Shades may vary due to the color and resolution of your computer screen and/or your particualr color printer output. Greenheck is not responsible or liable for color matches made with online color chart.

031

Greenheck offers 24 standard colors available in 70% KYNAR 500®/HYLAR 5000®, 50% KYNAR 500®/HYLAR 5000®, and Baked Enamel. These color retention and color uniformity. All finishes meet AAMA chalk, gloss and erosion specifications for weather and chemical exposure as well as dry film thickness requirements. Reference the back cover for finish type selection assistance.

represented in this brochure, custom colors are easily matched. Contact your local Greenheck representative for color matching requirements and possible additional lead-time or cost.



^{*}Model FSG-801 FEMA 361 Grille is limited to the 24 colors on this page only in a liquid powder paint formulation.

GF115

Portland Stone

GF106

Mica Colors

Disclaimer: This color chart is for reference only and is not to be used for final color matching. Shades may vary due to the color and resolution of your computer screen and/or your particualr color printer output. Greenheck is not responsible or liable for color matches made with online color chart.

Greenheck offers ten standard 2-coat Kynar 500®/Hylar 5000® mica colors. Formulated to reproduce the low-gloss metallic luster of anodized aluminum in a wider range of dynamic mica colors, these finishes offer many performance advantages over conventional anodic finishes, including superior resistance to salt spray, greater color uniformity, no discoloration from mortar and easier field repair and touch-up. Organic micas are comprised of natural minerals and crushed pearlescent that are resistant to the harmful effects of the environment compared to a synthetic 2-coat metallic which requires a third clear top-coat for comparable weather resistance.



Anodize Colors

The anodizing process creates an extremely hard, durable and aesthetically pleasing coating on aluminum. Greenheck offers seven industry standard anodize colors for our aluminum louver and architectural products that meat the AAMA-611 specification. All anodize colors are also available in a standard 2-coat 70% KYNAR 500®/HYLAR 5000® formulation (consult your local Greenheck representative).







GF207

GF208

GF209

Reference Chart

Choosing the right finish is as critical to a louver project as performance and ratings. The following chart puts complete application information at your fingertips to make the right choice.

Finish Type	Description/Application	Color Selection	Standard Warranty (Aluminum)
2-coat 70% KYNAR 500®/HYLAR 5000® AAMA 2605 – Dry film thickness 1.2 mil. 3-coat 70% KYNAR 500®/HYLAR 5000® AAMA 2605 – Dry film thickness 2.0 mil. (AKA: Duranar®, Fluoropon®, Trinar®, Flouropolymer, Polyvinylidene Fluoride, PVDF2, Mica, Pearlescent)	"Best." The premier finish for extruded aluminum. Tough, long-lasting coating has superior color retention and abrasive properties. Resists chalking, fading, chemical abrasion and weathering.	Standard Colors: Any of the 24 standard colors shown can be furnished in 70% or 50% KYNAR 500®/ HYLAR 5000® or Baked Enamel.	10 Years (Consult Greenheck for availability of extended warranty)
2-coat 50% KYNAR 500®/HYLAR 5000® AAMA 2604 – Dry film thickness 1.2 mil. (AKA: Acroflur®, Acrynar®)	"Better." Tough, long-lasting coating has excellent color retention and abrasive properties. Resists chalking, fading, chemical abrasion and weathering.	2-Coat Mica: Greenheck offers 9 standard 2-coat Mica colors. Other colors are available. Consult Greenheck for possible extra cost when	5 Years
Baked Enamel AAMA 2603 – Dry film thickness 0.8 mil. (AKA: Acrabond Plus®, Duracron®)	"Good." Provides good adhesion and resistance to weathering, corrosion and chemical stain.	selecting non-standard colors or special finishes.	1 Year
Color Anodize AA-M10C21A44 (>0.7 mil)	"Two-step" anodizing is produced by following the normal anodizing step with a second, colorfast electrolytic process.	Light, Medium or Dark Bronze; Champagne; Black	5 years
Clear Anodize 215 R-1 AA-M10C21A41 (>0.7 mil)	Clear, colorless and hard oxide aluminum coating that resists weathering and chemical attack.	Clear	5 years
Clear Anodize 204 R-1 AA-M10C21A31 (0.4-0.7 mil)	Clear, colorless and hard oxide aluminum coating that resists weathering and chemical attack.	Clear	1 Year
Industrial coatings	Greenheck offers a number of indeas Hi-Pro Polyester, Epoxy, and Pea Greenheck Product Specialist for application information.	ermatector™. Consult	Consult Greenheck
Mill	Materials may be supplied in natu galvanized steel finish when norm acceptable and there is no concerchange.	N/A	

Finishes meet or exceed AAMA 611, AAMA 2605, AAMA 2604, and AAMA 2603 requirements.


Please consult www.greenheck.com for complete information on standard and extended paint warranties.

Paint finish warranties are not applicable to steel products.



Prepared to Support Green Building Efforts



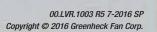



















Louver Products Severe Duty, Stationary, Operable





BUILDIN Ω VALU Ш z

November 2017

Louver Selection Guide



Louve	ers	Airt	flow	Aes	sthetics			AMCA Certificati	ons		
Туре	Model	Free Area 48 x 48 in. (sq. ft.)	Free Area 48 x 48 in. (%)	Depth (in.)	Blade Alignment	Wind Driven Rain	Water Penetration	Air Performance	Sound	AMCA 540	AMCA 550
	EDD-401	8.22	51	4	Н		✓	✓			
	EDD-601	8.21	51	6	Н		✓	✓			
	EHM-601	7.91	49	6	Н		✓	✓			
Drainable Blade	ESD-202	6.01	38	2	Н		✓	✓			
page 9	ESD-403	8.00	50	4	Н		✓	✓			
	ESD-435	8.92	56	4	Н		✓	✓			
	ESD-603	8.36	52	6	Н		✓	✓			
	ESD-635	9.41	59	6	Н		✓	✓			
	EDJ-401	8.32	52	4	Н		✓	✓			
_	EDJ-430	8.35	52	4	Н		✓	✓			
	EDJ-601	8.69	54	6	Н		✓	✓			
Drainable Head	EDK-402	8.49	53	4	Н		✓	✓			
page 10	EDK-430	8.80	55	4	Н		✓	✓			
	ESID-430 DISCHARGE	10.88	68	4	Н						
	ESID-430 INTAKE	7.66	48	4	Н						
	ESJ-202	6.01	38	2	Н		✓	✓			
Non-Drainable	ESJ-401	8.44	53	4	Н		✓	✓			
page 11	ESJ-602	8.73	55	6	Н		✓	✓			
	ESK-402	8.45	53	4	Н		✓	✓			
	EAD-401	6.54	41	4	Н		✓	✓			
	EAD-601	7.34	46	6	Н		✓	✓			
	EAD-635	8.73	55	6	Н		✓	✓			
Adjustable Blade page 12	EAH-401	6.48	41	4	Н		✓	✓			
F-92	EAH-690 (45° BLADE)	6.32	40	6	Н			✓			
	EAH-690 (90° BLADE)	10.87	68	6	Н			✓			
	EAC-401	6.34	40	4	Н		✓	✓			
	EAC-601	7.41	46	6	Н		✓	✓			
	EACA-601	7.68	48	6	Н		✓	✓			
	EACC-401	5.41	34	4	Н						
Combination	EACC-601	6.20	39	6	Н						
Louver/Damper page 13	EACN-601	7.18	45	6	Н		✓	✓			
	ECD-401	7.60	48	4	Н		✓	✓			
	ECD-601	7.32	46	6	Н		✓	✓			
	GCE-402	6.36	40	4	Н						
	GCI-402	6.39	40	4	Н						





Greenheck louvers are available in unlimited standard configurations that meet or exceed the industry's most stringent test performance standards while also providing exceptional aesthetic appeal. Choose from extruded aluminum or galvanized steel louvers with a variety of accessories, blade, head and sill designs to fit your application perfectly. Nearly all products are available in both standard and custom finishes and colors that compliment building facades.

In-House Product Testing

Our modern testing facilities position us as an industry leader in developing products that have exceptional performance. Our laboratory is devoted exclusively to the development and testing of louver products to meet the latest AMCA, Miami-Dade County and other industry standards.

Quick Build

Greenheck's Louver quick build program consists of the most complete offering of louvers anywhere. Customers may select 1, 3, 5, and 10-day manufacturing cycles with mill finished louvers or 5, 10, and 15-day manufacturing cycles with finished louvers.

Options and Accessories

We have a full line of accessories, so whether your project necessitates security bars or filter racks, we have what you need. An extensive line of standard finishes, including Kynar® paint, baked enamel paint, industrial coatings or anodize finishes are also available. In addition to our complete line of standard colors, our custom color matching capabilities are endless. These accessories and options allow Greenheck to complete your project just as you envision it.

Building Value in Air

Greenheck Louvers deliver value to mechanical engineers by helping them select the correct louver for their specific application with a comprehensive collection of top quality, innovative louver products. We offer extra value to contractors by providing easy-to-install, competitively priced, reliable products that arrive on time.

Drainable Head



- Drainable head member improves ability to prevent water penetration due to an additional drain gutter
- Models EDJ-430 and EDK-430 have optional 30-degree blades designed to maximize free area
- Model ESID-430 is an air intake/discharge louver, which helps prevent the short cycling of air













Model Name	Depth Blade Thickness Thickness License		Blade Thickness Thickness Licensed 4' x 4' Unit Point of Water		Beginning Point of Water Penetration	Pressure Drop @ 6,000 CFM Intake Velocity	Max Intake Volume Flow Rate	Exhaust Volume Flow Rate @ 0.15			
Name	(111.)	Otyle	(in.)	(in.)	Ratings	ft ²	%	(ft/min)	(in. wg)	(cfm)	in. wg (cfm)
EDJ-401	4	J	0.081	0.081	AP, WP	8.32	52	963	0.08	8012	8325
EDJ-430	4	J	0.081	0.081	AP, WP	8.35	52	941	0.06	7861	9139
EDJ-601	6	J	0.081	0.081	AP, WP	8.69	54	998	0.07	8673	8563
EDK-402	4	K	0.081	0.081	AP, WP	8.49	53	934	0.08	7930	8219
EDK-430	4	K	0.081	0.081	AP, WP	8.80	55	1002	0.06	8818	9309
ESID-430 (Intake)	4	K	0.081	0.081	NR	7.66	48	-	-	4979	-
ESID-430 (Discharge)	4	DC	0.081	0.081	NR	10.88	68	-	-	-	13056

Combination Louver/Damper



- Maintains a stationary appearance when adjustable blades are closed
- ECD Series offer exposed on-blade linkage
- EAC Series and Model EACN-601 offer concealed linkage and center pivot operable blades
- Model EACA-601 incorporates airfoil blades
- EACC Series offer both concealed blade linkage and concealed electric actuator
- GCE and GCI Series require an exhaust or intake fan for proper operation

















Model Name	Depth (in.)	Blade Style	Blade Thickness (in.)	Frame Thickness (in.)	AMCA Licensed Ratings	Free <i>A</i> 4' x 4'		Beginning Point of Water Penetration	Pressure Drop @ 6,000 CFM Intake Velocity	Max Intake Volume Flow Rate	Exhaust Volume Flow Rate @ 0.15
								(ft/min)	(in. wg)	(cfm)	in. wg (cfm)
EAC-401	4	DA	0.081	0.125	AP, WP	6.34	40	1192	0.15	7557	6062
EAC-601	6	DA	0.081	0.125	AP, WP	7.41	46	1020	0.11	7558	7146
EACA-601	6	DAF	0.081	0.125	AP, WP	7.68	48	1221	0.06	9377	9586
EACC-401	4	DA	0.081	0.125	NR	5.41	34	1192	0.20	6449	5171
EACC-601	6	DA	0.081	0.125	NR	6.20	39	1020	0.15	6324	5977
EACN-601	6	J	0.081	0.125	AP, WP	7.18	45	1193	0.09	8566	7593
ECD-401	4	DA	0.081	0.081	AP, WP	7.60	48	1018	0.09	7737	7769
ECD-601	6	DA	0.081	0.081	AP, WP	7.32	46	1035	0.09	7576	7700
GCE-402	4	JG	0.081	0.081	NR	6.36	40	-	-	-	-
GCI-402	4	JG	0.081	0.081	NR	6.39	40	-	-	-	-









Inverted available with WILL option only.

Specifications


Luminaire

Height: (18.4 cm)

18" Width: (45.7 cm)

9" Depth: (22.8 cm)

18 lbs Weight:

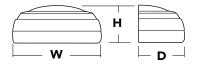

Optional Back Box (BBW)

Height:

(10.2 cm)

5-1/2" Width: (14.0 cm)

1-1/2" Depth:



Catalog Notes Туре

Introduction

The classic Architectural Wall Sconce is now available with the latest in LED technology. The result is a long-life, maintenance-free product with typical energy savings of 75% compared to metal halide versions. The integral battery backup option provides emergency egress lighting, without the use of a back-box or remote gear, so installations maintain their aesthetic integrity.

The MRW LED is ideal for replacing existing 50 -175W metal halide wall-mounted products. The expected service life is 20+ years of nighttime use.

Ordering Information

EXAMPLE: MRW LED 2 10A700/40K SR3 MVOLT DDBTXD

MRW LED							
Series	Light Engines	Performance Package	Distribution	Voltage	Mounting	Options ³	Finish (required)
MRW LED	1 One engine (10 LEDs) 2 Two engines (20 LEDs)	700 mA options: 10A700/30K 3000K 10A700/40K 4000K 10A700/50K 5000K	SR2 Type II SR3 Type III SR4 Type IV	MVOLT 1 120 1 208 1 240 1 277 1 347 480	Shipped included (blank) Surface mount Shipped separately ² BBW Surface-mounted back box UTS Uptilt 5 degrees	Shipped installed PE Photoelectric cell, button type ^{4,5} SF Single fuse (120, 277, 347V) ⁴ DF Double fuse (208, 240, 480V) ⁴ DMG 0-10V dimming driver (no controls) ELCW Emergency battery backup, non CEC compliant ^{6,7} WLU Wet location door for up orientation ⁸ PIR Motion/ambient light sensor ⁹ DS Dual switching ¹⁰ Shipped separately VG Vandal guard WG Wire guard	DDBXD Dark bronze DBLXD Black DNAXD Natural aluminum DWHXD White DSSXD Sandstone DDBTXD Textured dark bronze DBLBXD Textured black DNATXD Textured natural aluminum DWHGXD Textured white DSSTXD Textured sandstone

Emergency Battery Operation

The emergency battery backup (ELCW option) is integral to the luminaire - no external housing required! This design provides reliable emergency operation while maintaining the aesthetics of the product.


All ELCW configurations include an independent secondary driver with an integral relay to immediately detect AC power loss. Dual light engines are wired in parallel so both engines operate in emergency mode and provide additional component redundancy. These design features meet various interpretations of NFPA 70/NEC 2008 -

The emergency battery will power the luminaire for a minimum duration of 90 minutes (maximum duration of three hours) from the time supply power is lost, per International Building Code Section 1006 and NFPA 101 Life Safety Code Section 7.9, provided luminaires are mounted at an appropriate height and illuminate an open space with no major obstructions

The examples below show illuminance of 1 fc average and 0.1 fc minimum of the single-engine Type IV product in emergency mode.

WST LED 1 10A700/40K SR4 MVOLT ELCW 10' x 10' Gridlines 8' and 12' Mounting Height

8' MH

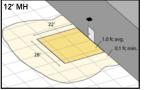

NOTES

- MVOLT driver operates on any line voltage from 120-277V (50/60 Hz). Specify 120, 208, 240 or 277 options only when ordering with photocell (PE), fusing (SF, DF), or dual switching (DS).
- May also be ordered separately as an accessory. Ex: WSBBW DDBXD U. Must specify finish.
- Must be ordered with fixture; cannot be field installed.
- Not available with MVOLT option. Button photocell (PE) can be ordered with a dedicated voltage option. Single fuse (SF) requires 120, 277 or 347 voltage option. Double fuse (DF) requires 208, 240 or 480 voltage option.
- Not available with 480V option. Not available with motion/ambient light
- Integral battery pack is rated for -20° to 60°C operating temperature. ELCW warranty is 3-year period. Not available with 347V or 480V. Not available with WLU.
- Cannot be used in California. Not qualified under CEC T20 requirements. WLU not available with PIR or ELCW.
- witch SFOD-7-ODP control (photocell included); uide for details. Includes ambient light sensor. Specifies the Senso Not available with "PE" option (button type photocell). Dimming driver standard. Not available with WLU, VG or WG.
- Provides 50/50 luminaire operation via two independent drivers and light engines on two separate circuits. Not available with one engine, MVOLT, ELCW, WLU, SF, or DF. Must specify voltage; voltage must be the same for both drivers. When ordered with photocell (PE) or motion sensor (PIR), only the primary power source leads will be controlled.



Performance Data

Lumen Output

Lumen values are from photometric tests performed in accordance with IESNA LM-79-08. Data is considered to be representative of the configurations shown, within the tolerances allowed by Lighting Facts

Light			System Watts	Dist.		(40K 4000K, 70 CRI)	
Engines	(mA)	Package	(MVOLT ¹)	Туре	Nominal Lumens	В	U	G	LPW
	1 700 10A700/K		SR2	2,005	1	0	1	84	
(10 LED-)		10A700/K	24W	SR3	2,029	1	0	1	84
(10 LEDs)				SR4	1,959	1	0	1	82
2				SR2	3,944	1	0	1	84
(20 LEDs)	2 700	10A700/K	47W	SR3	4,028	1	0	1	86
(20 LEDS)				SR4	3,851	1	0	1	82 84

See electrical load chart for 347/480V system watts.

Lumen Ambient Temperature (LAT) Multipliers

Use these factors to determine relative lumen output for average ambient temperatures from 0-40 °C (32-104 °F).

Amb	Ambient					
0°C	32°F	1.10				
10°C	50°F	1.06				
20°C	68°F	1.02				
25°C	77°F	1.00				
30°C	86°F	0.98				
40°C	104°F	0.92				

Projected LED Lumen Maintenance

Data references the extrapolated performance projections for the MRW LED 2 10A700 petrormance and 25°C ambient, based on 10,000 hours of LED testing (tested per IESNA LM-80-08 and projected per IESNA TM-21-11).

To calculate LLF, use the lumen maintenance factor that corresponds to the desired number of operating hours below. For other lumen maintenance values, contact factory.

Operating Hours	0	25,000	50,000	100,000
Lumen Maintenance Factor	1.0	0.94	0.88	0.77

Electrical Load


					Curre	nt (A)		
Light Engines	Drive Current (mA)	System Watts	120	208	240	277	347	480
	700	24W	0.24	0.14	0.12	0.1	-	-
1	700	29W1	-	-	-	-	0.09	0.07
2	700	47W	0.44	0.27	0.23	0.20	-	-
2		53W1	-	-	-	-	0.17	0.12


¹ Higher wattage is due to electrical losses from step-down transformer.


Photometric Diagrams


To see complete photometric reports or download .ies files for this product, visit Lithonia Lighting's MRW LED homepage.


Isofootcandle plots for the MRW LED 2 10A700/40K SR2, SR3, and SR4. Distances are in units of mounting height (12').

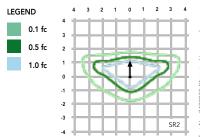

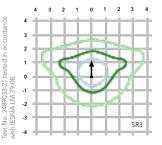

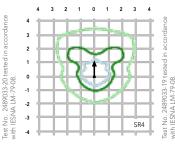

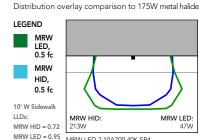

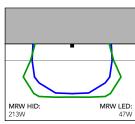

MRW LED 2 10A700 40K SR4, MRW 175M FT Probe, 12' Mounting Ht

FEATURES & SPECIFICATIONS

INTENDED USE

The classic architectural shape of the MRW LED was designed for applications such as hospitals, schools, malls, restaurants, and commercial buildings. The long life LEDs and driver make this luminaire nearly maintenance-free.

CONSTRUCTION

The single-piece die-cast aluminum housing integrates secondary heat sinks to optimize thermal transfer from the internal light engine heat sinks and promote long life. The driver is mounted in direct contact with the casting for a low operating temperature and long life. The die-cast door frame is fully gasketed with a one-piece solid silicone gasket to keep out moisture and dust, providing an IP65 rating for the luminaire.

Exterior parts are protected by a zinc-infused Super Durable TGIC thermoset powder coat finish that provides superior resistance to corrosion and weathering. A tightly controlled multi-stage process ensures a minimum 3 mils thickness for a finish that can withstand extreme climate changes without cracking or peeling. Standard Super Durable colors include dark bronze, black, natural aluminum, sandstone and white. Available in textured and non-textured finishes

OPTICS

Precision-molded acrylic lenses are engineered for superior distribution, uniformity, and spacing in wall-mount applications. Light engines are 4000K (70 CRI). The MRW LED has zero uplight and qualifies as a Nighttime Friendly™ product, meaning it is consistent with the LEED® and Green Globes™ criteria for eliminating wasteful uplight.

ELECTRICAL

Light engine(s) consist of 10 high-efficacy LEDs mounted to a metal core circuit board and integral aluminum heat sinks to maximize heat dissipation and promote long life (100,000 hrs at 25°C, L77). Class 2 electronic driver has a power factor >90%, THD <20%. Easily-serviceable surge protection device meets a minimum Category B (per ANSI/IEEE C62.41.2).

INSTALLATION

A universal mounting plate with integral mounting support arms allows the fixture to hinge down for easy access while making wiring connections.

LISTINGS

CSA certified to U.S. and Canadian standards. Light engines are IP66 rated; luminaire is IP65 rated and suitable for wet locations when mounted with the lenses down. WLU option offers wet location listing in "up" orientation. Rated for -30°C minimum ambient.

WARRANTY-5YR

5-year limited warranty. Complete warranty terms located at

Note: Actual performance may differ as a result of end-user environment and application. All values are design or typical values, measured under laboratory conditions at 25 °C. Specifications subject to change without notice.



ARB Proposal

Ra Coffee Company, LLC



Christina and Daniel Guzman 118 Londonderry Rd. Goose Creek, SC 29445 425-328-0466 www.racoffeecompany.com



Architectural Review Board

APPLICATION / INFORMATION SUMMARY

DEPARTMENT OF PLANNING AND ZONING 843-797-6220 EXT. 1118

P.O. Drawer 1768

519 N. Goose Creek Blvd.

Goose Creek, South Carolina 29445-1768

www.cityofgoosecreek.com

Fax: 843-863-5208

Property Address: 110	S. Goose Creek Blvd	TMS No.: 2431207019
Review request:	For:	Preliminary meeting date requested: May 21,2018
☐ Conceptual	□New Construction ☑Alterations / Additions	Appeal Decision of Architectural Review Board
Preliminary Final	☐Repairs or repaint with no changes	☑Color Change ☐ Demolition
Property Owner: KO.		time phone: 805-914-4488
Applicant: Dan+1	Christma Guzman Day	ytime phone: 425-328-0466
ARB Meeting Representative	: Dant Christina Guztman coi	ntact Information: Same
Applicant's mailing address:	118 Londonderny Rd	
City: GODSE CV.		te: SC Zip: 29445
Applicant's e-mail address	guzmancd 0115@gmail	.com
Applicant's relationship:	Downer Design Professional Cont	ractor RealEstate Agent/Broker Dother
Materials/Colors	Used: (specific color(s)/manufacture #'s listed: samp	les must be presented to Board attached)
	(Example: Building Materials, Exterior Colors, L	
Pléase see	attached statement	OF WOYK.
	Scope of Work: (please give a detaile	ed description)
1000000000	attached Scope of We	K. Laudit & Design
PIEUSE SEE	ariached scope of voi	s Ricagous i restir
There by acknowledge by m	ny signature below that the foregoing application is cor	nplete and accurate and that I am the owner of
the subject property or an a	uthorized representative. I authorize the subject proper ctural Review Board of the City of Goose Creek on the d	ate specified.
1	witing Himmer	SQ 5/1/18
Applicant's signature:	uwuu Aungmury =	Date:
Print name legibly:	astina Guzman / Dar	1 Guziman

Exterior: Column clean & paint



Behr- Semi Gloss Interior Door and door moldings



Coffee Paint

SPAYROLL S GOVERNMENT \$2 PARTY \$PAYDAY LOANS

Ra Coffee Commany

- · Front canvas façade removed
 - Repair and texture stucco as needed
- (3) Addition of front Qty 2 canvas awning(s)
- Addition of front light fixtures
- (5) Circular Sign Front of Building
 - Illuminated. Quoted through Carolina Sign.





3=Awnings and light fixtures



Awnings Commercial Wind Rated




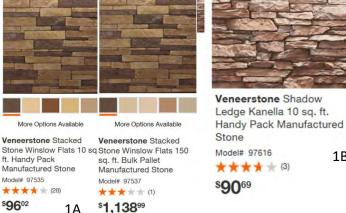

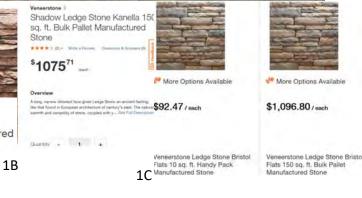




- Metallic portions of roof
- BEHR RP-31
- Chaparral Brown
- Metal portions of roof & side metallics to be painted

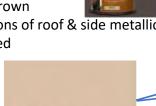



Upper portion of building (all sides)


- Asphalt seal coat &
- strip parking area
- Pressure wash and clean exterior concrete & asphalt prior to seal.

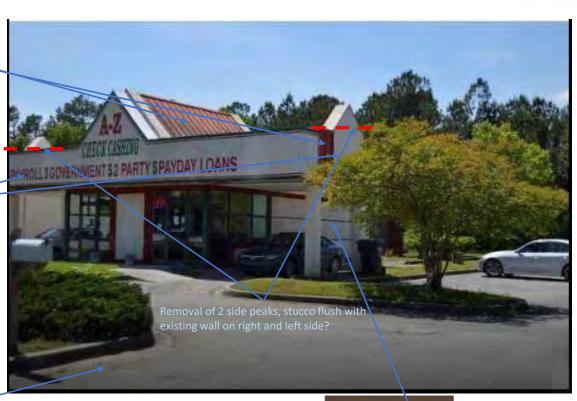



Stucco patch or blend before paint




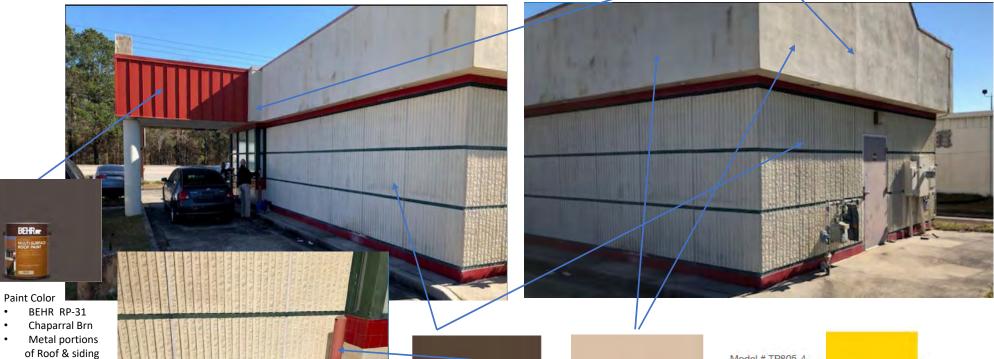

- Remove bottom row of tile around building
- Stucco texture & paint to match building
- Areas with décor rock will not need stucco after tile is removed

BEHR N170-7 Baronial Brn Flat Masonry Paint Lower portion of building (all sides) And exterior back door



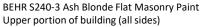



Super Traffic yellow marking paint





More Options Available

Veneerstone Stacked

sq. ft. Bulk Pallet

Model# 97537

\$1,13899

Manufactured Stone

Stone Winslow Flats 10 sq. Stone Winslow Flats 150

More Options Available

Veneerstone Stacked

Manufactured Stone

ft. Handy Pack

*** (28)

Model# 117535

Veneerstone Shadow


Model# 97616

\$9069

*** (3)

Ledge Kanella 10 sq. ft. Handy Pack Manufactured

1B

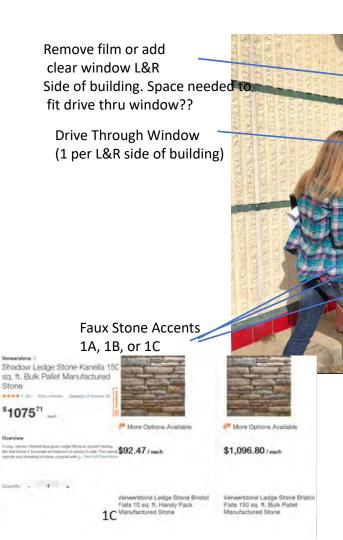

Paint All Aluminum Window Trim Around front and sides of building

- Metallic window frames-paint external
- BEHR RP-31
- Chaparral Brown



Exterior Drive Thru Window Options:



800-621-5045 ready@ready access.com PRICE Quote \$940.00 per window + freight (estimate \$285+/-* total)



4 Standard Sizes Available

- 47 1/2"W x 43 1/2"H with a 19" wide x 35" high service opening 47 1/2"W x 35 3/4"H with a 19" wide x 27" high service opening
- 47 1/2"W x 35 3/4"H with a 15" wide x 27" high service opening (Calf. App. Restricted Requirements)
- + 35 3/4"W x 35 3/4"H with a 13-1/2" wide x 27" high service opening (Manual Open/Self Closer or MOER Only) Custom sizes available upon request. "Please note that all 275 fully automatic wendows must have all least 19°W service opening."

4 Modes of Operation

- · 275 Manual Open/Self Closing Ready Access Patented Technology -So simple to operate, the service door opens effortlessly and automatically slides shut when operator releases the handle. (can be adjusted in field to be
- · 275 Manual Open/Manual Close -When total control over the operation of the window is needed.
- 275 M.O.E.R. (Manual Open/Electronic Release) -The 275 Manual Open/Electronic Release Window has a manual open, self closing operation which electro-magnetically holds the window open until the operator finishes their transaction and steps out of the presence sensor. Two electrical hook up options: New MOSP Design
- · 275 Fully Automatic Electric -With a hands-free operation the 275 Electric Window is ideal for heavy traffic situations. It provides easier operation and speedier service than the manual operating windows "Please note that at 275-fully automatic windows must have at least 19"W service opening



Model SC-CUSTOM Flush mount Manual Self-closing slider, 36-1/2" W x 29-1/2"H with 1/4" clear tempered glass in dark bronze or clear anodized framing is \$1305.00/each + freight + sales tax if applicable; 4 week lead time





- Roof Replace. Remove vents from
- HVAC System- Replace 3 ton. & center metallic duct
- Below truss exposed.

- Top metal side wall cap replaced
- with roof paint to match BEHR S240-3 Ash Blonde Flat





• Stucco repair patch both L &R sides

Underside paneling, clean up and use existing

Other Options:

- Exterior Can light fixtures reuse
- Landscape Cleanup & improvement?
- Clean-up, prep & paint trash holding area
- (BEHR S240-3 Ash Blonde Flat for stucco & BEHR RP-31 Chaparral Brown for metallic front)





40-50 Inch Weatherproof TV Enclosure-

Digital TV menu or Illuminated menu board case L&R side of building next to drive through window (Power Required for either option)












Power source and wiring to office for security system

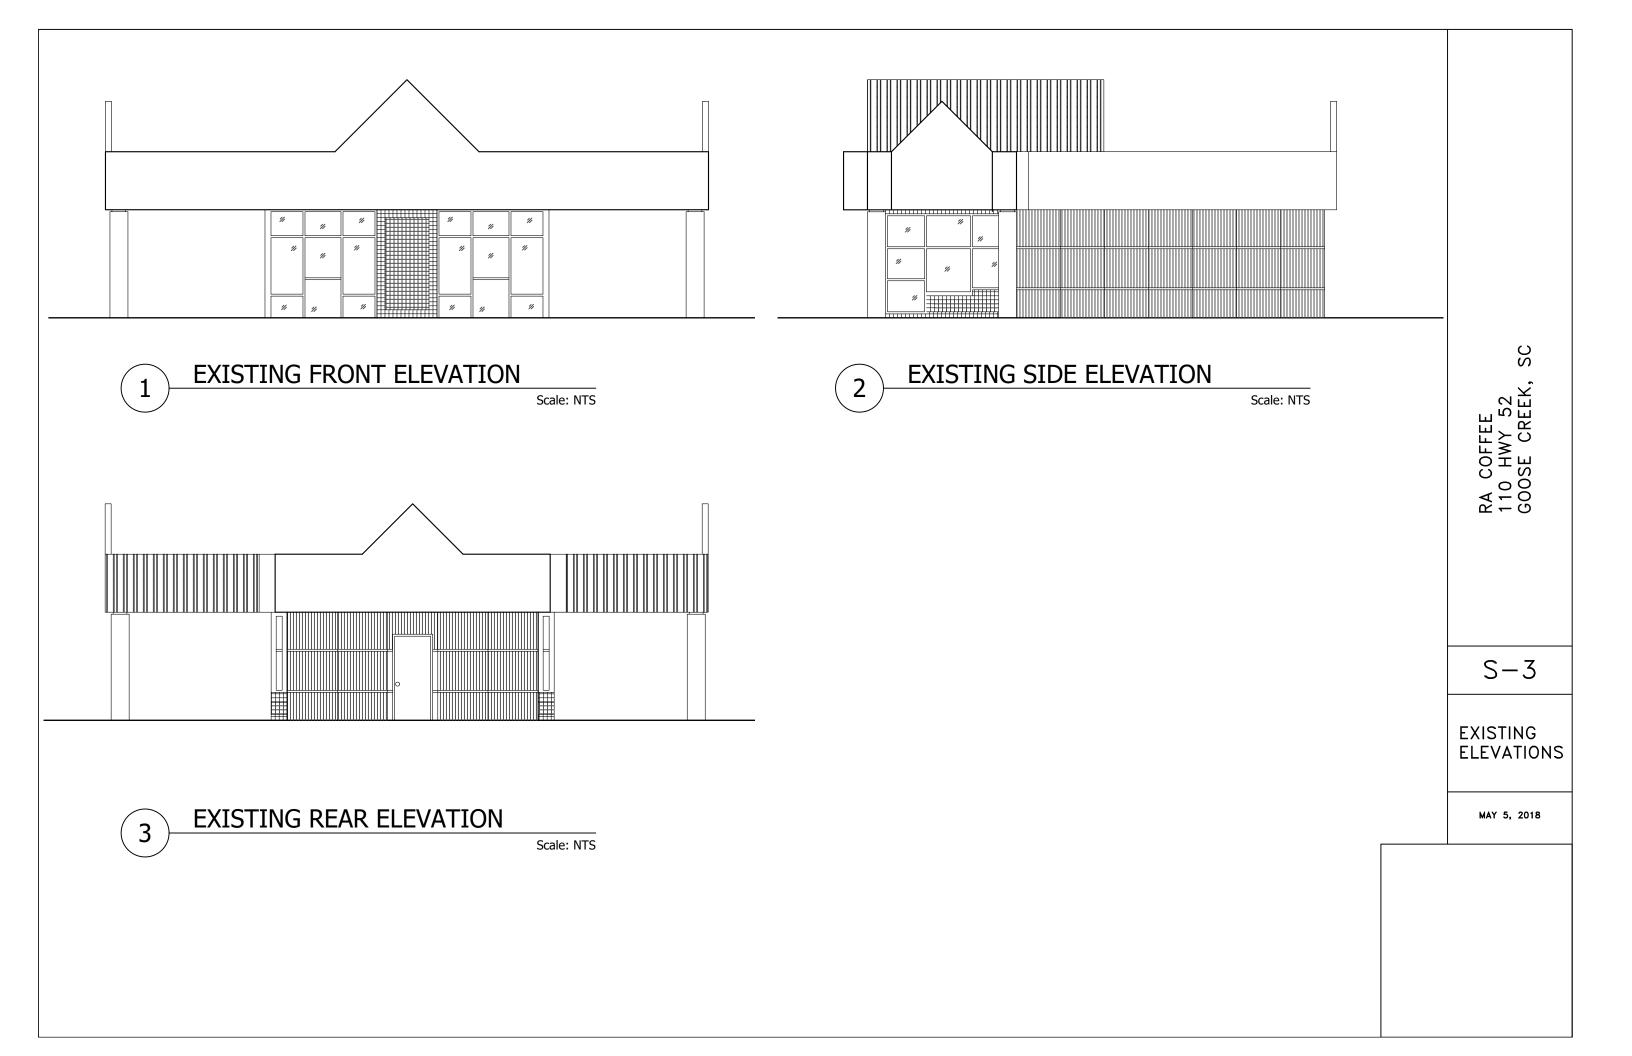


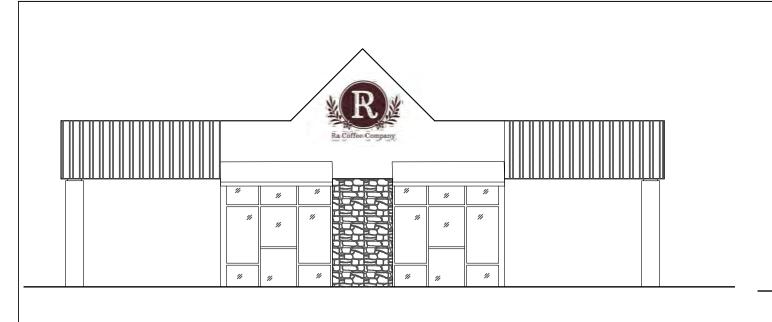

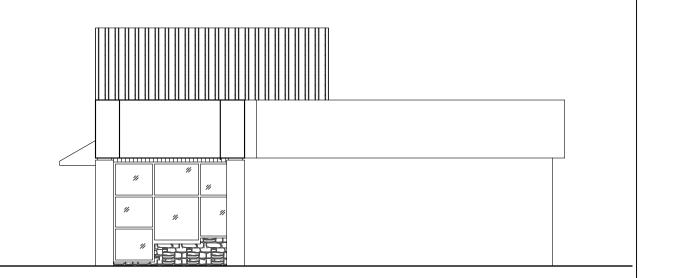

PROPOSED FRONT ELEVATION

Scale: NTS

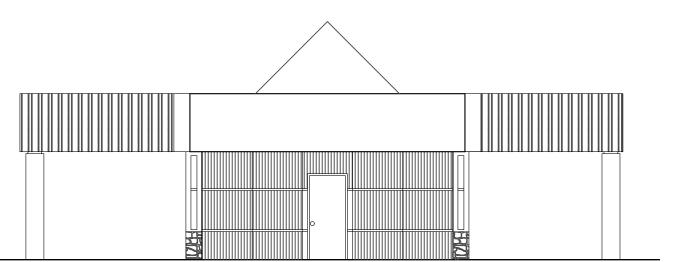

PROPOSED REAR ELEVATION

Scale: NTS

PROPOSED SIDE ELEVATION

Scale: NTS


RA COFFEE 110 HWY 52 GOOSE CREEK,


SC

S-4

NEW ELEVATIONS

MAY 5, 2018

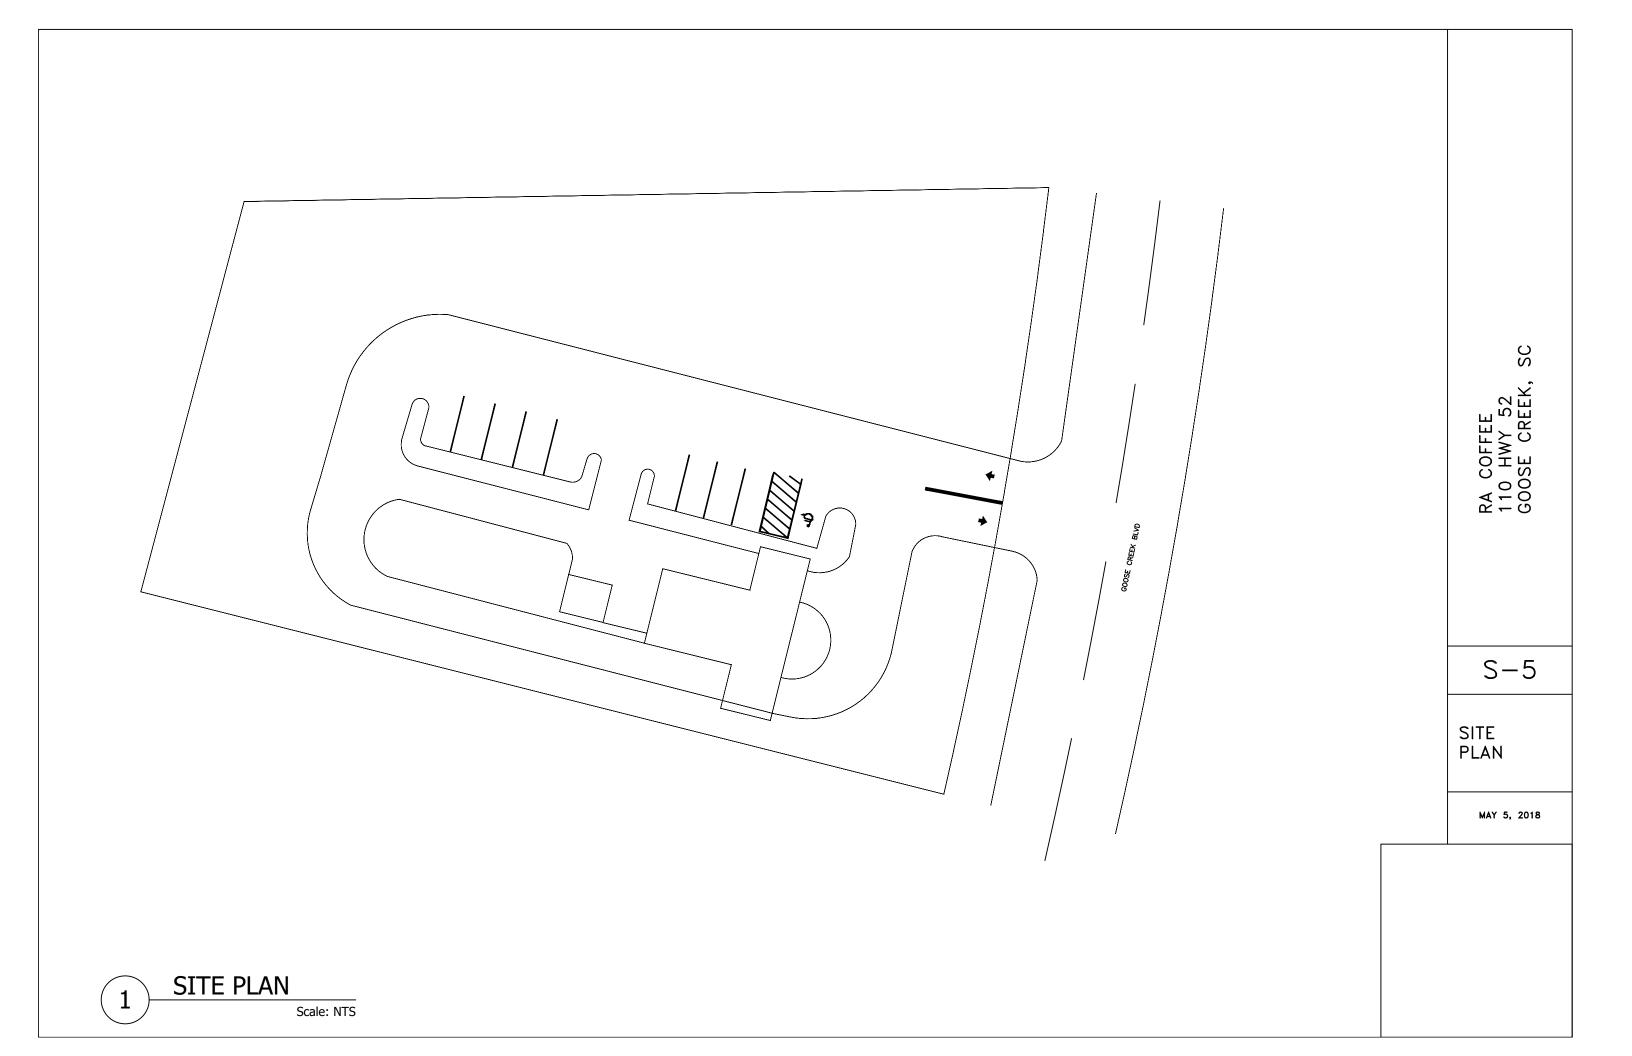

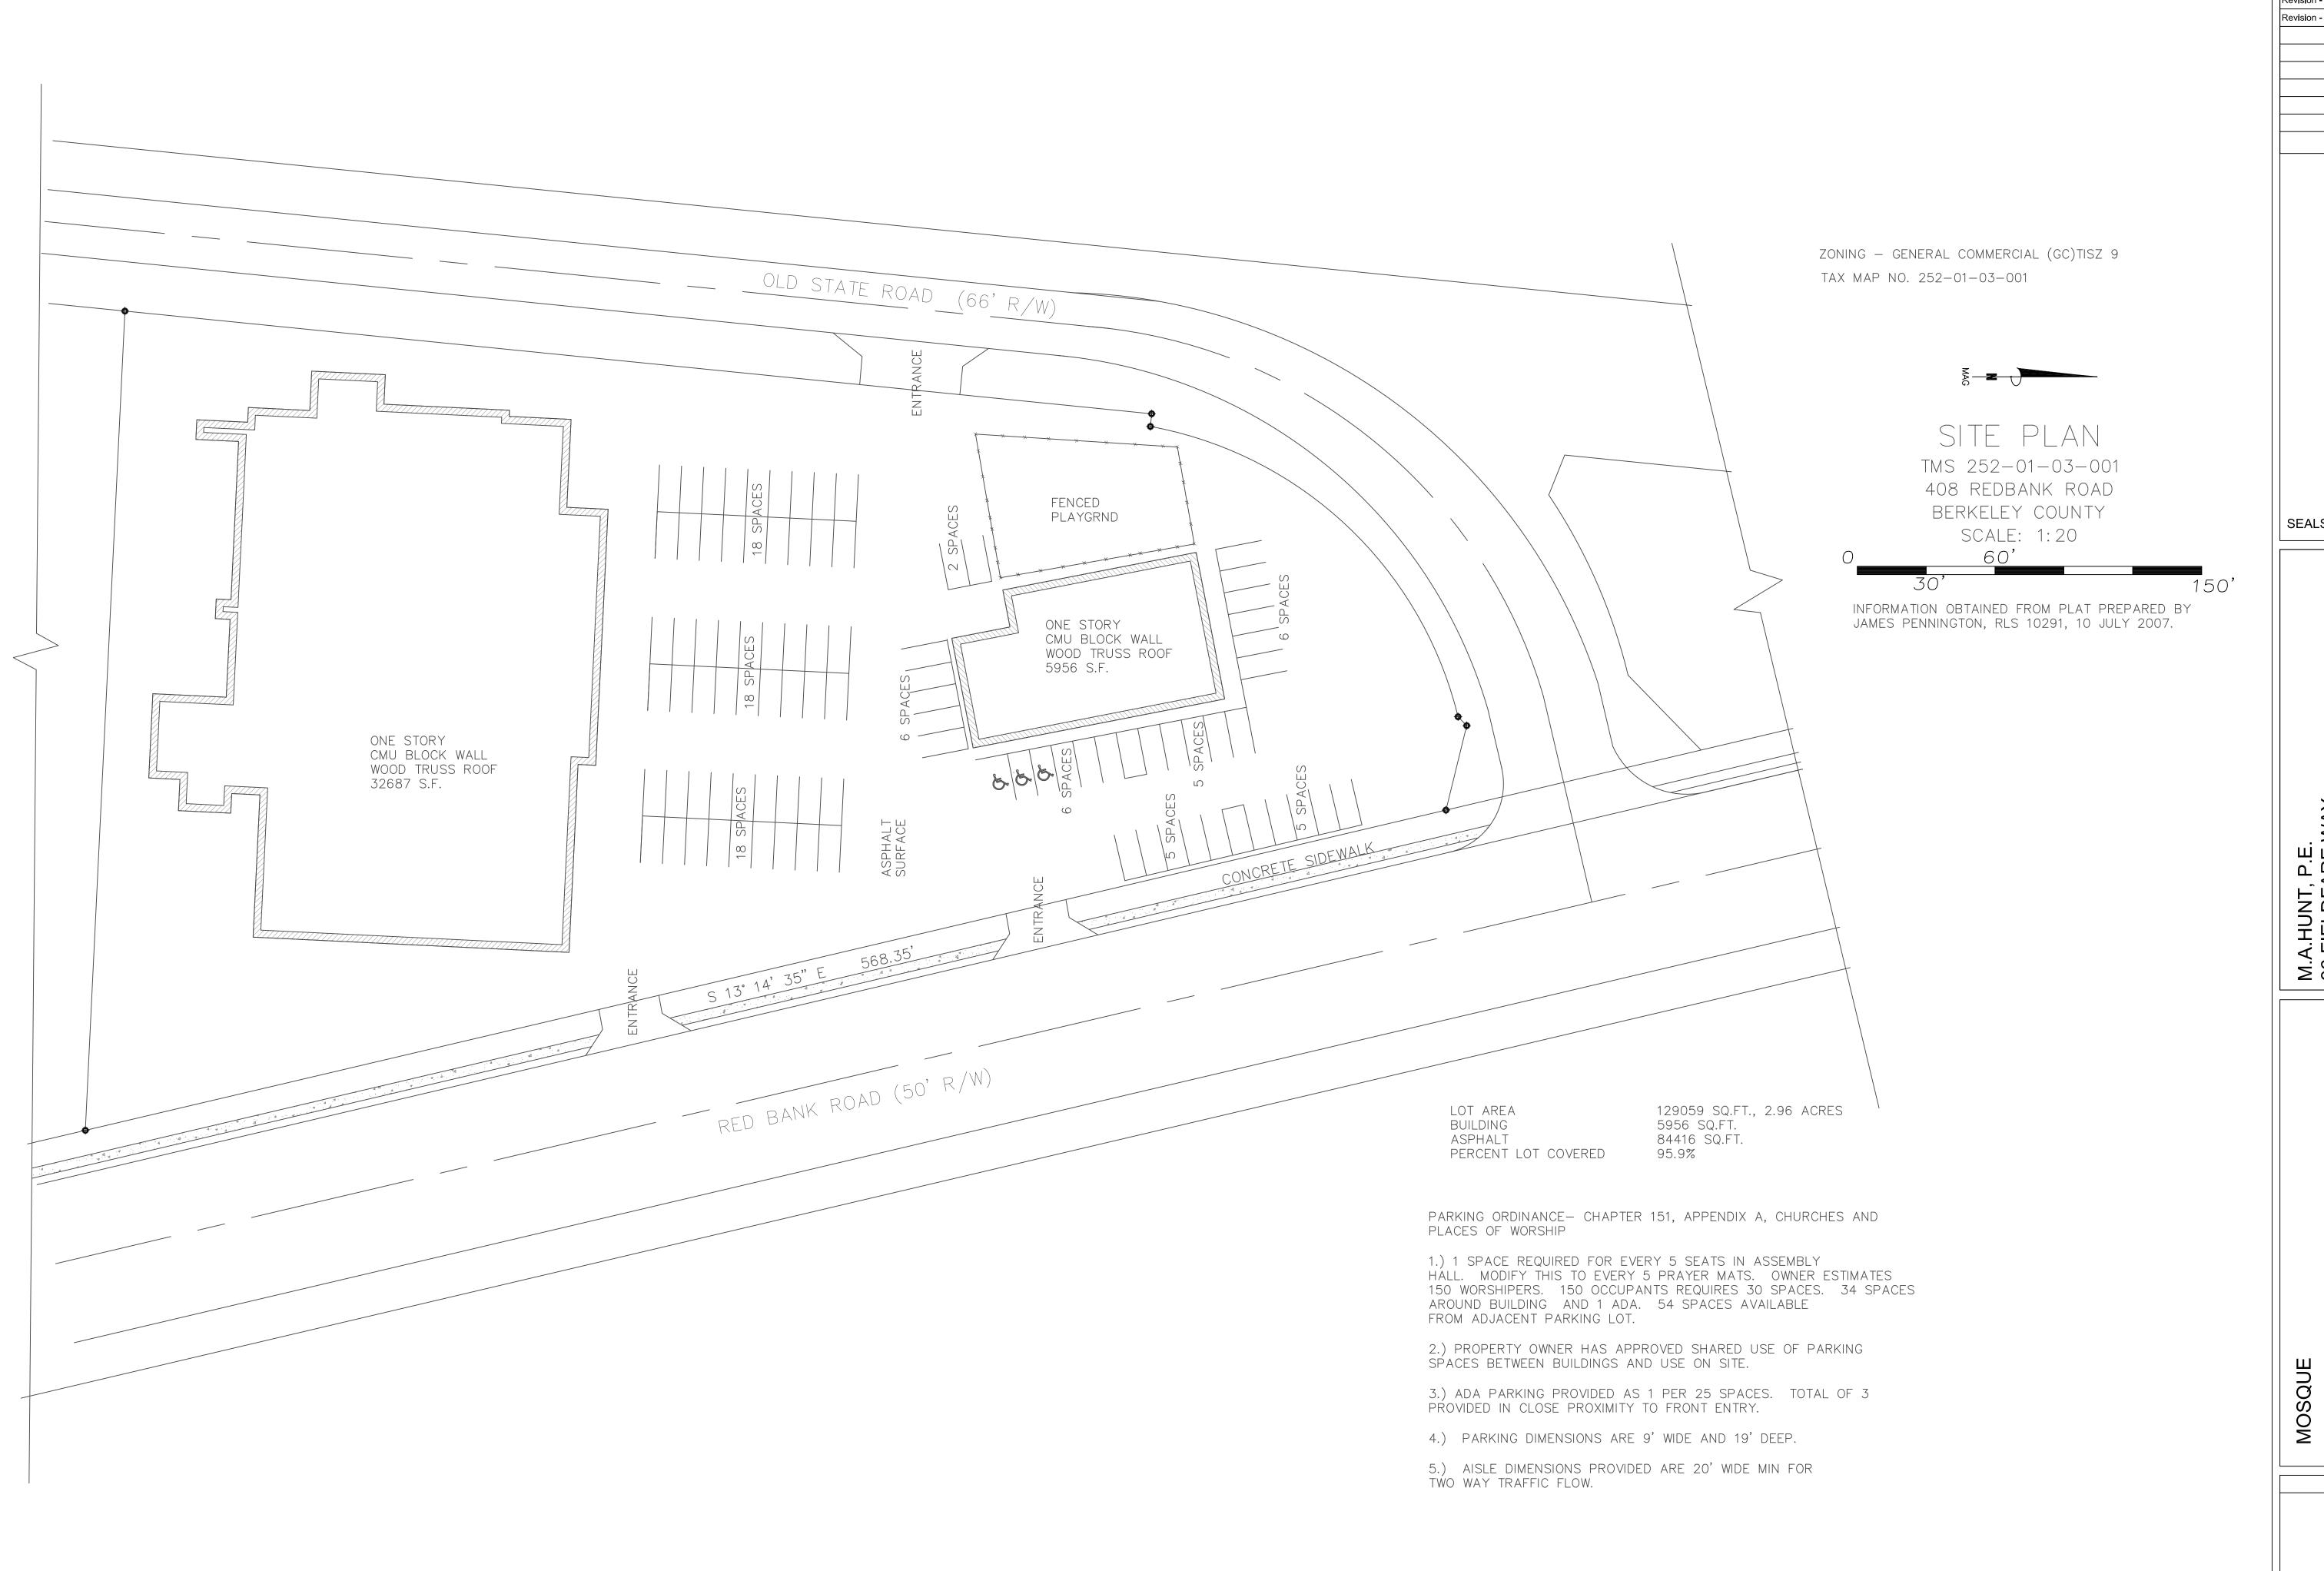

Revision - 0 For Permitting Date 3/30/18
Revision - 1 For Permitting Date


SEALS

96 FIELDFARE WAY
CHARLESTON, S.C., 29414
843-696-7623
MATTHEWAHUNTPE@HOTMAIL.C

MOSQUE
408 RED BANK ROAD

SITE PLAN


C 100

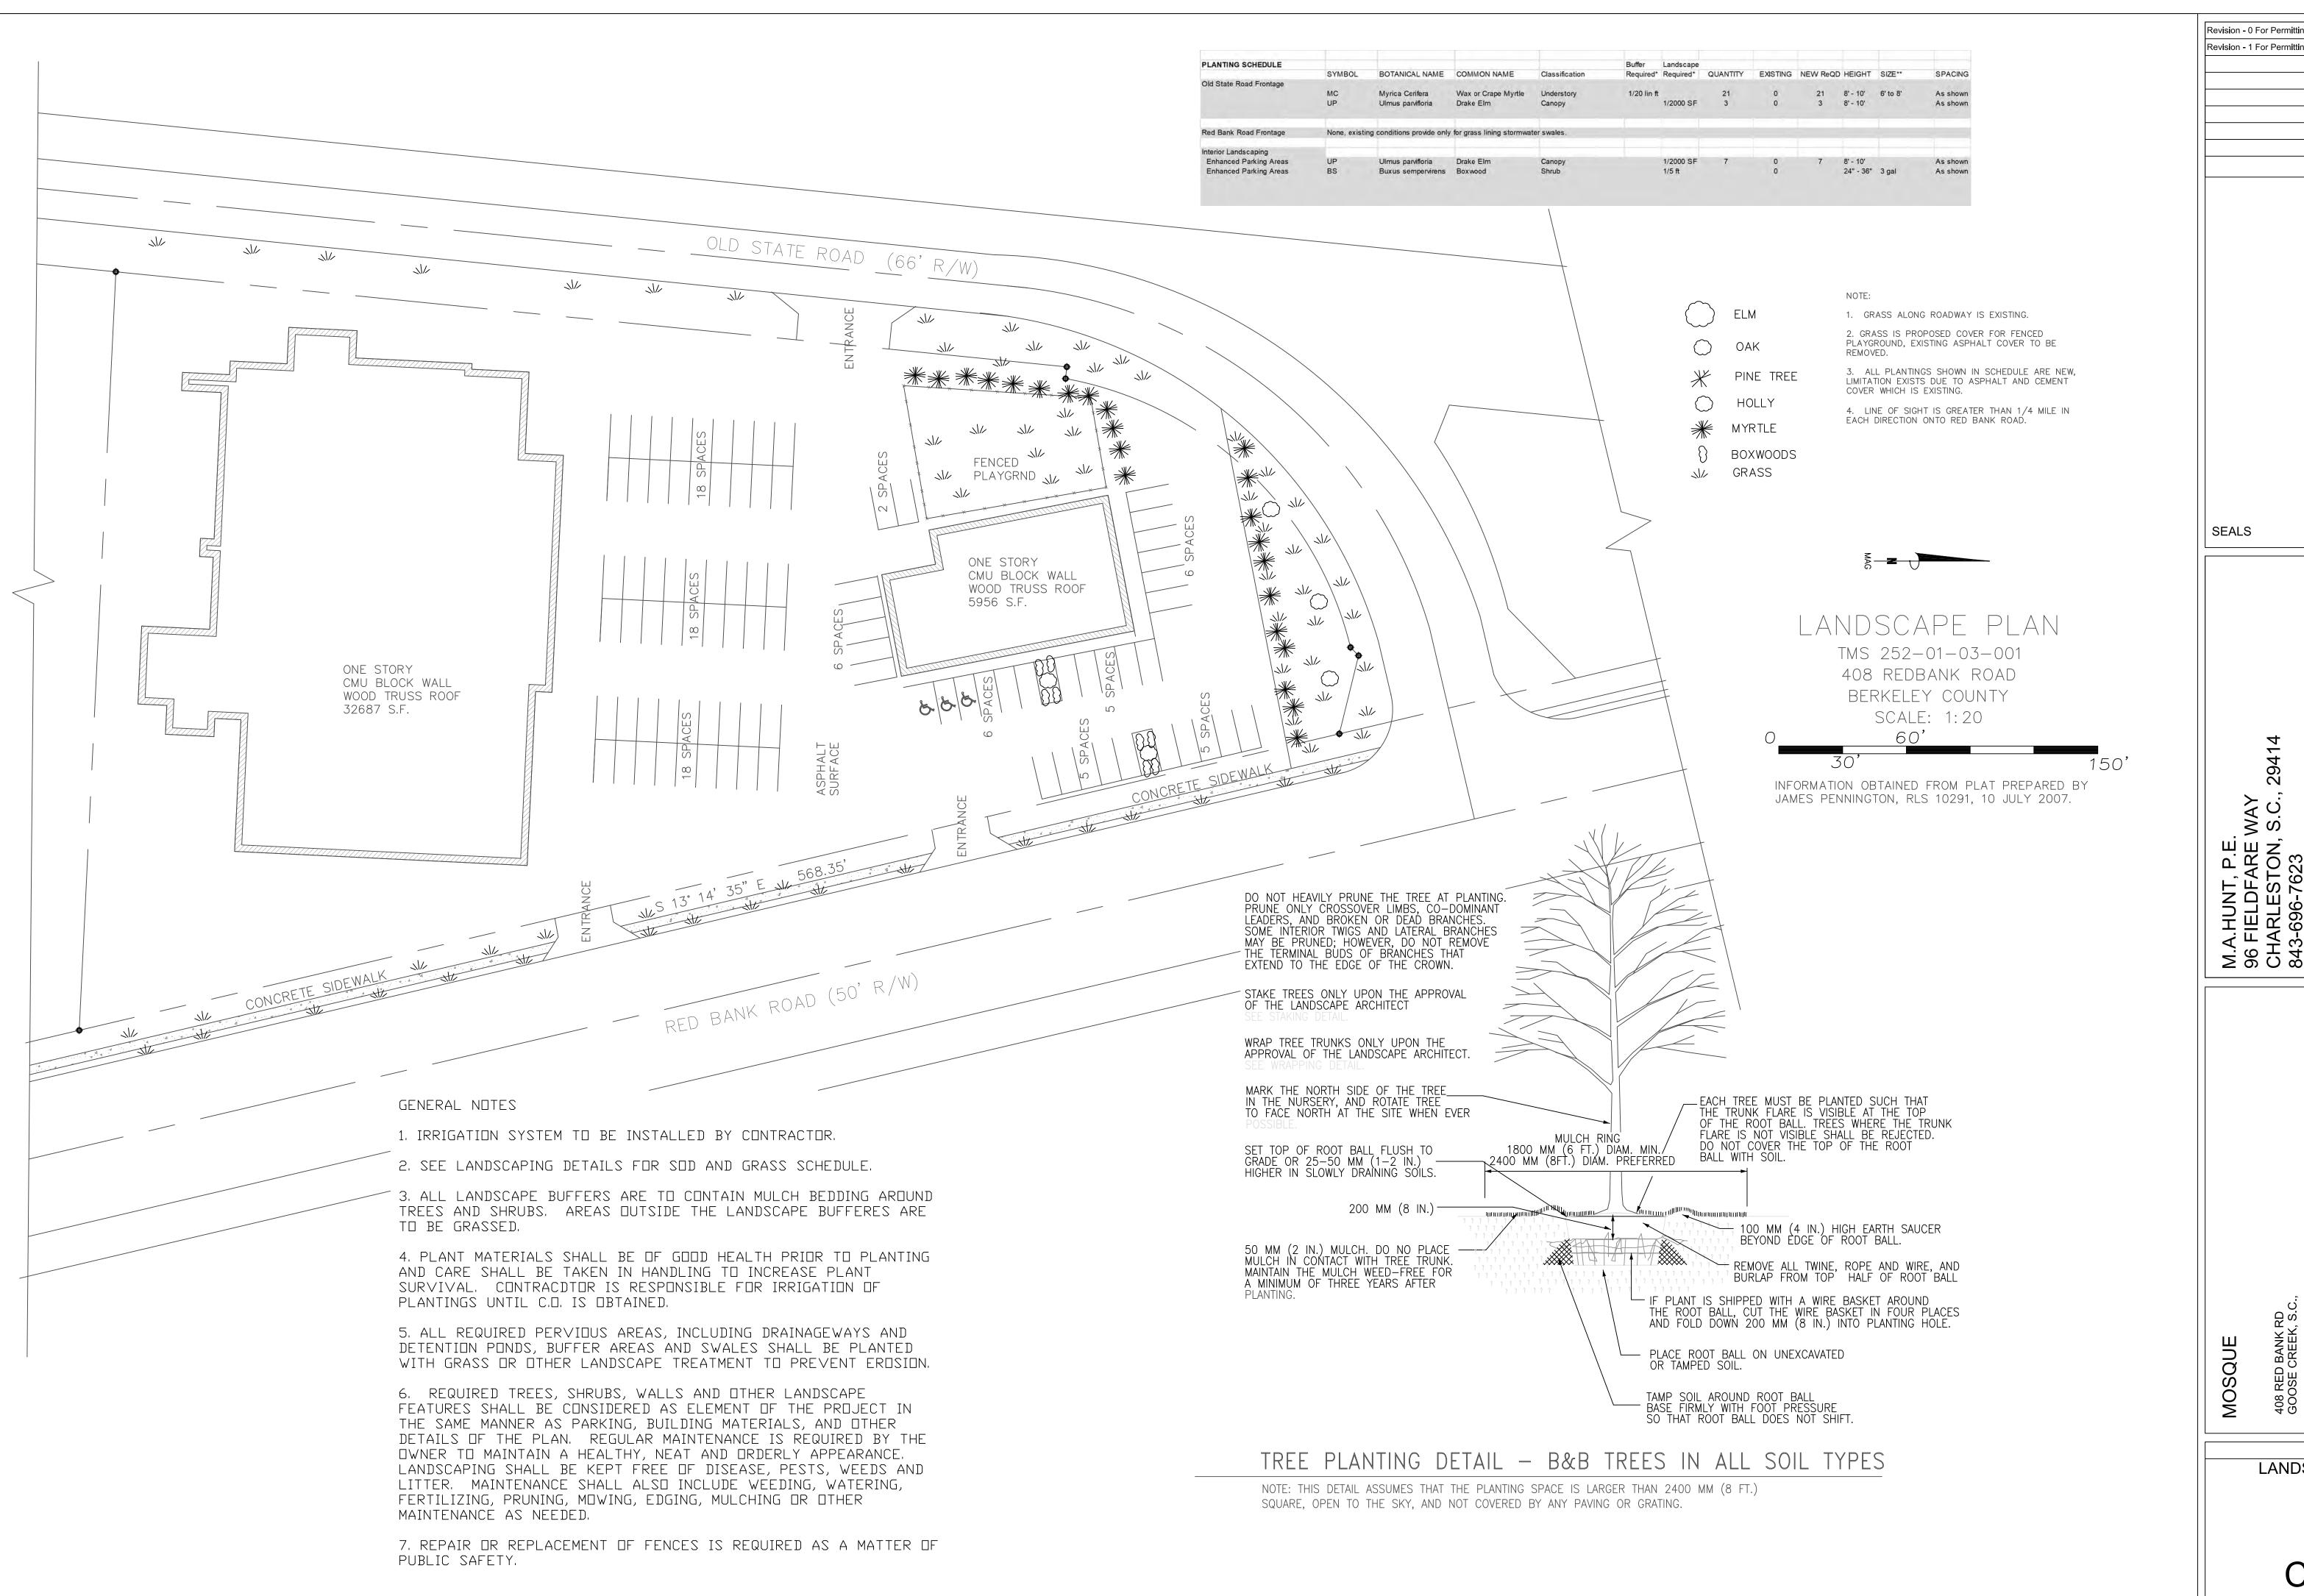



Revision - 0 For Permitting Date 3/30/18 Revision - 1 For Permitting Date


M.A.HUNT, P.E. 96 FIELDFARE V CHARLESTON, 843-696-7623 MATTHEWAHUN


LANDSCAPING

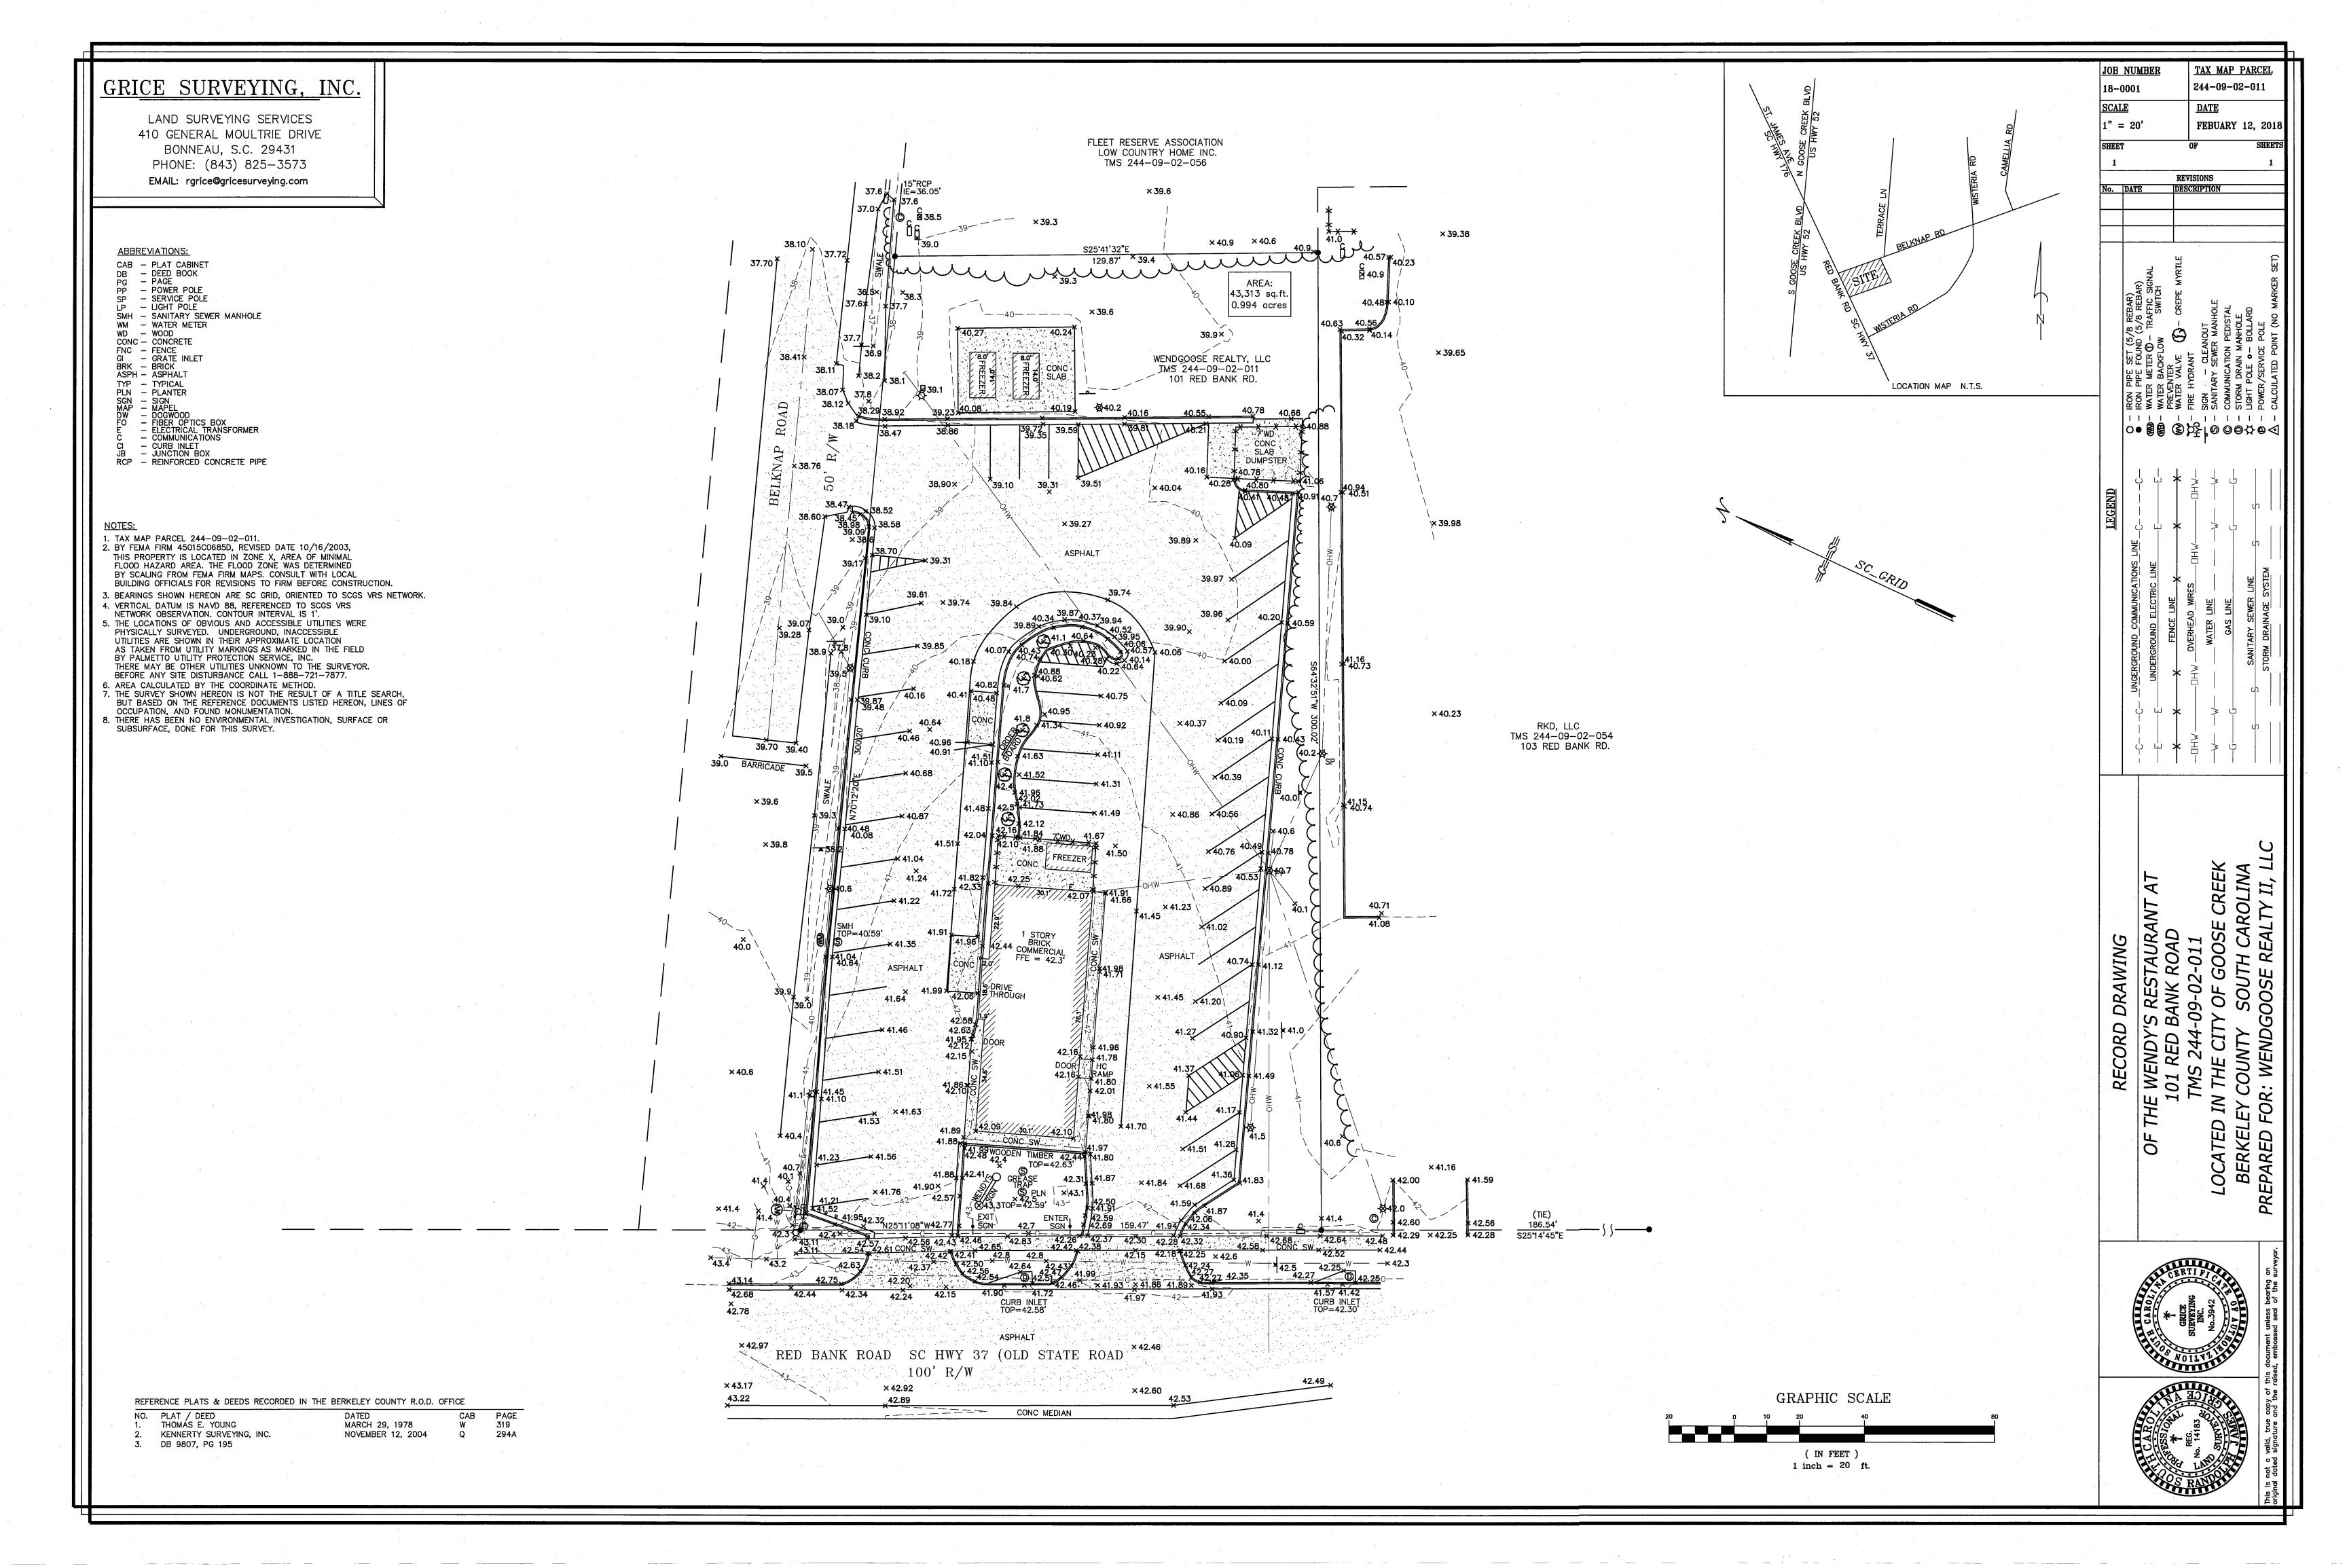


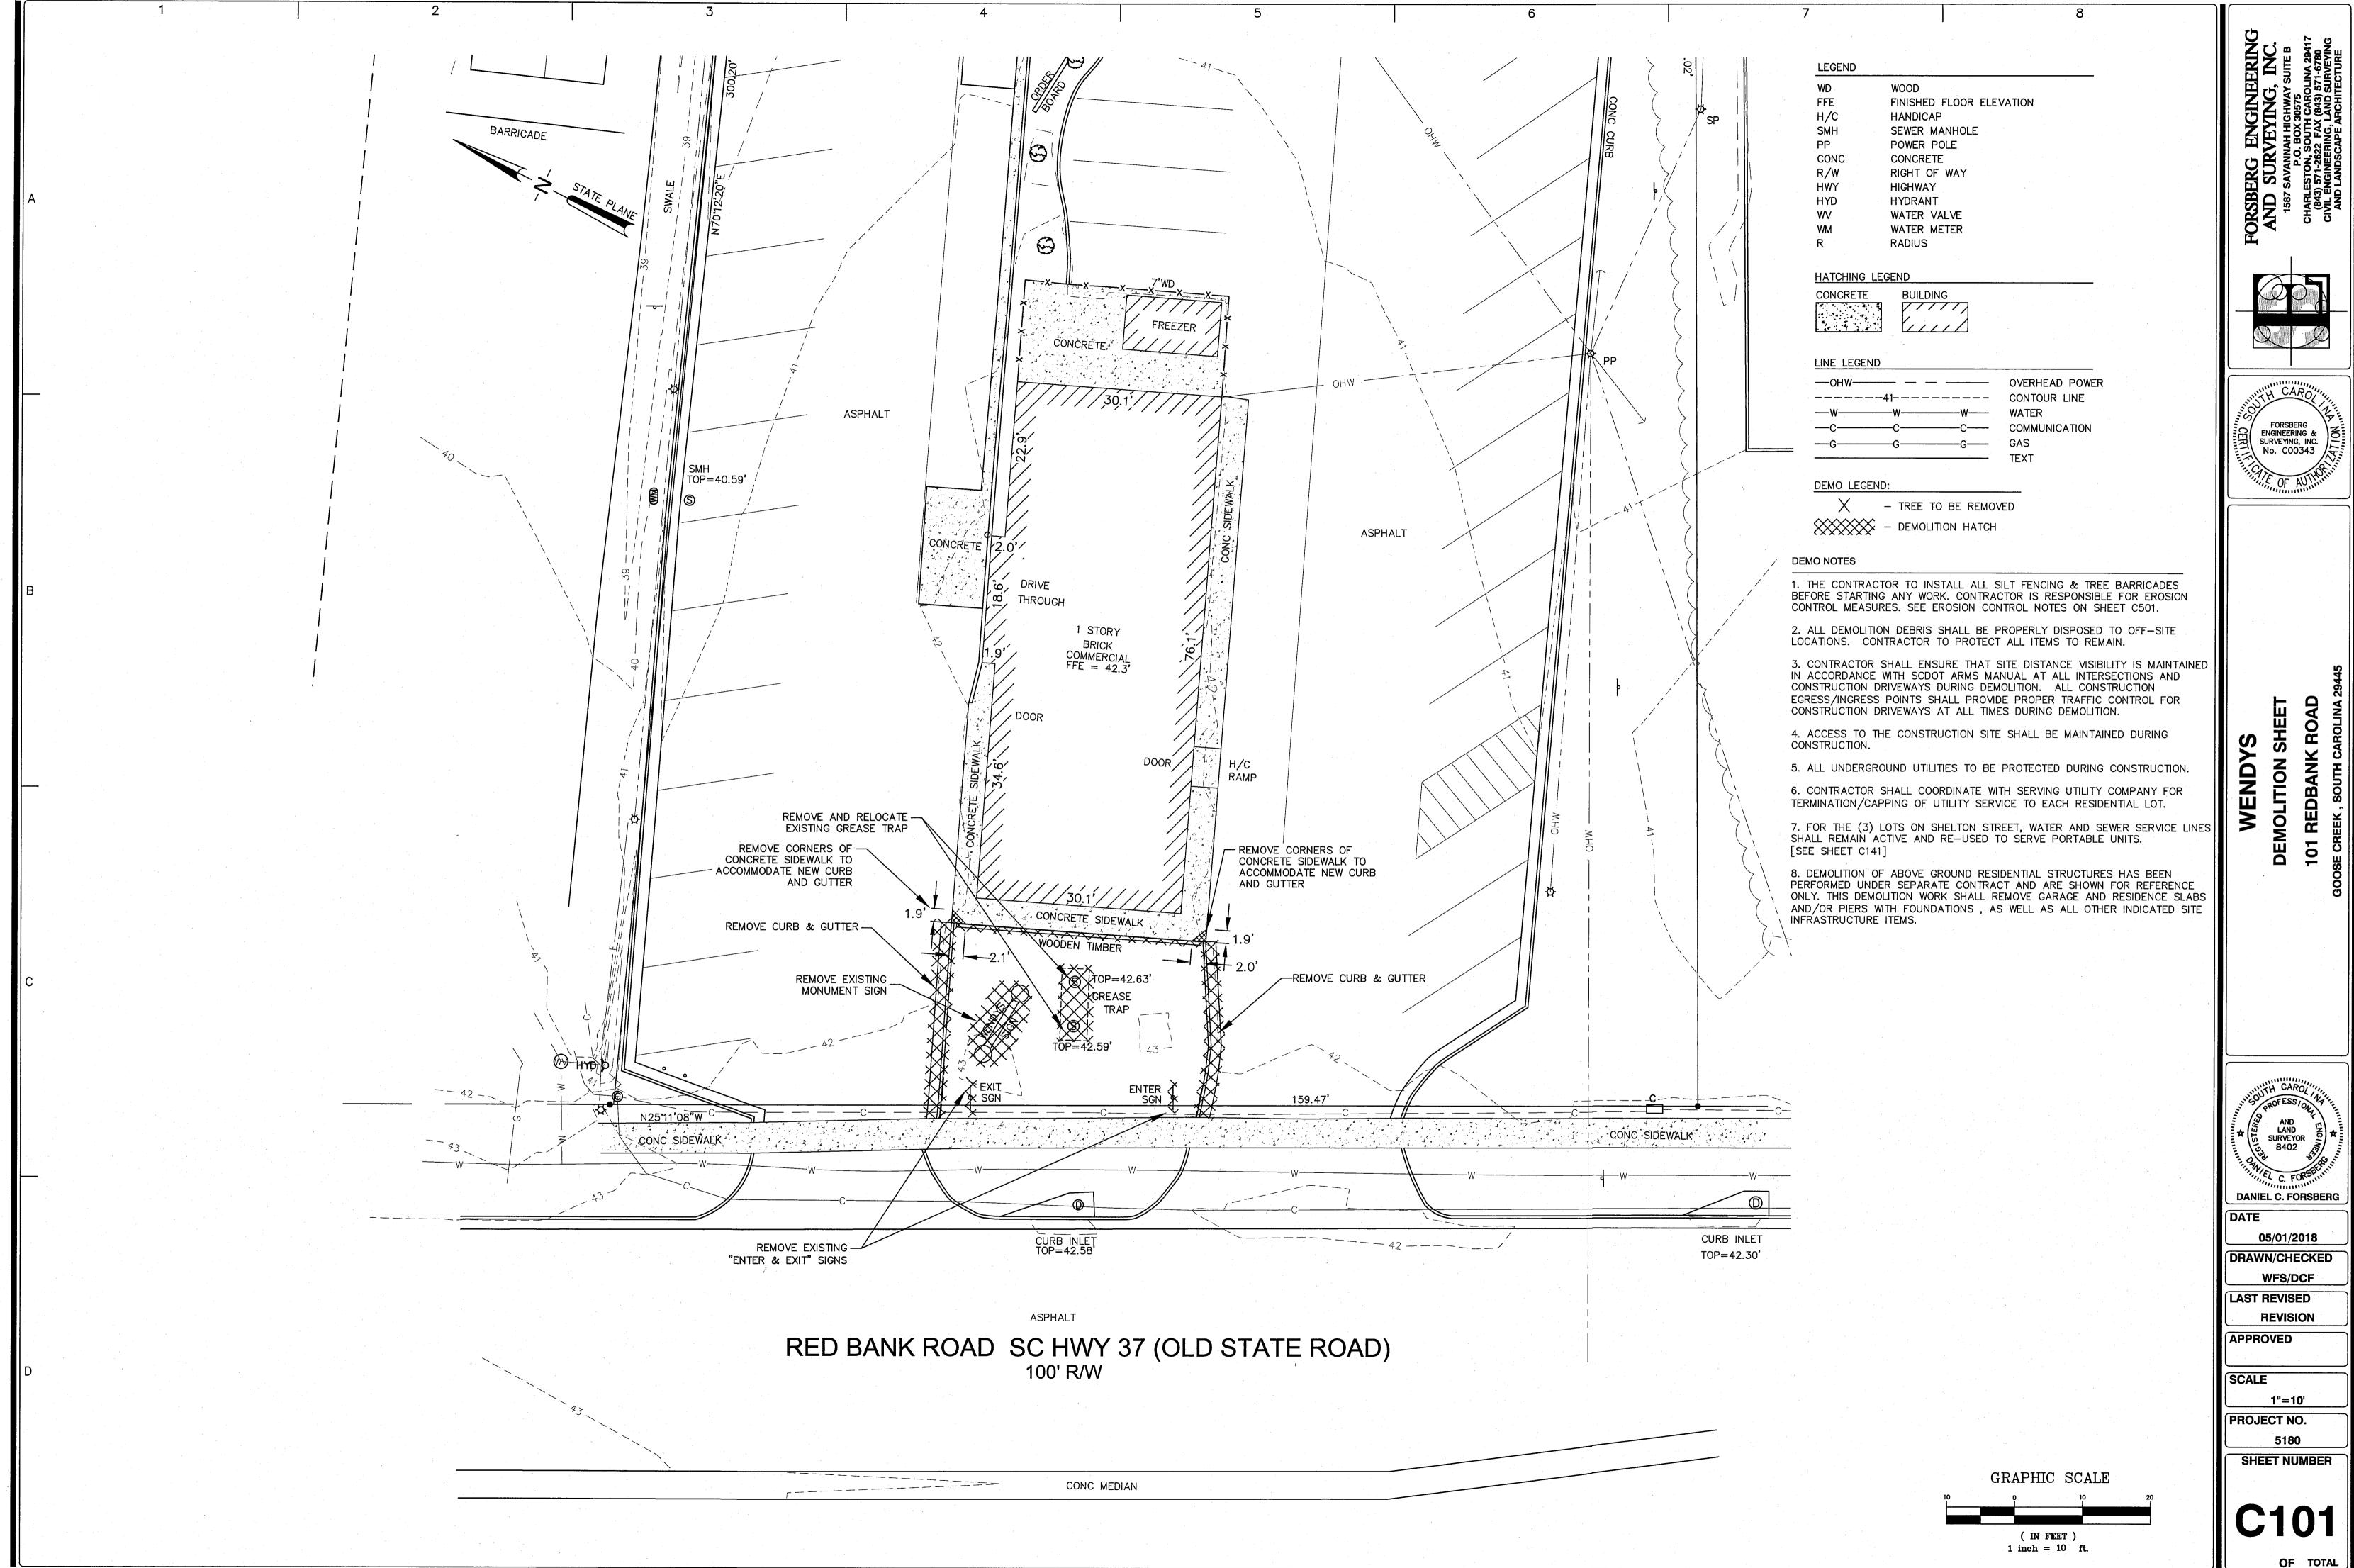

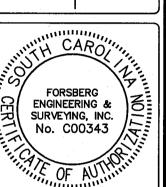


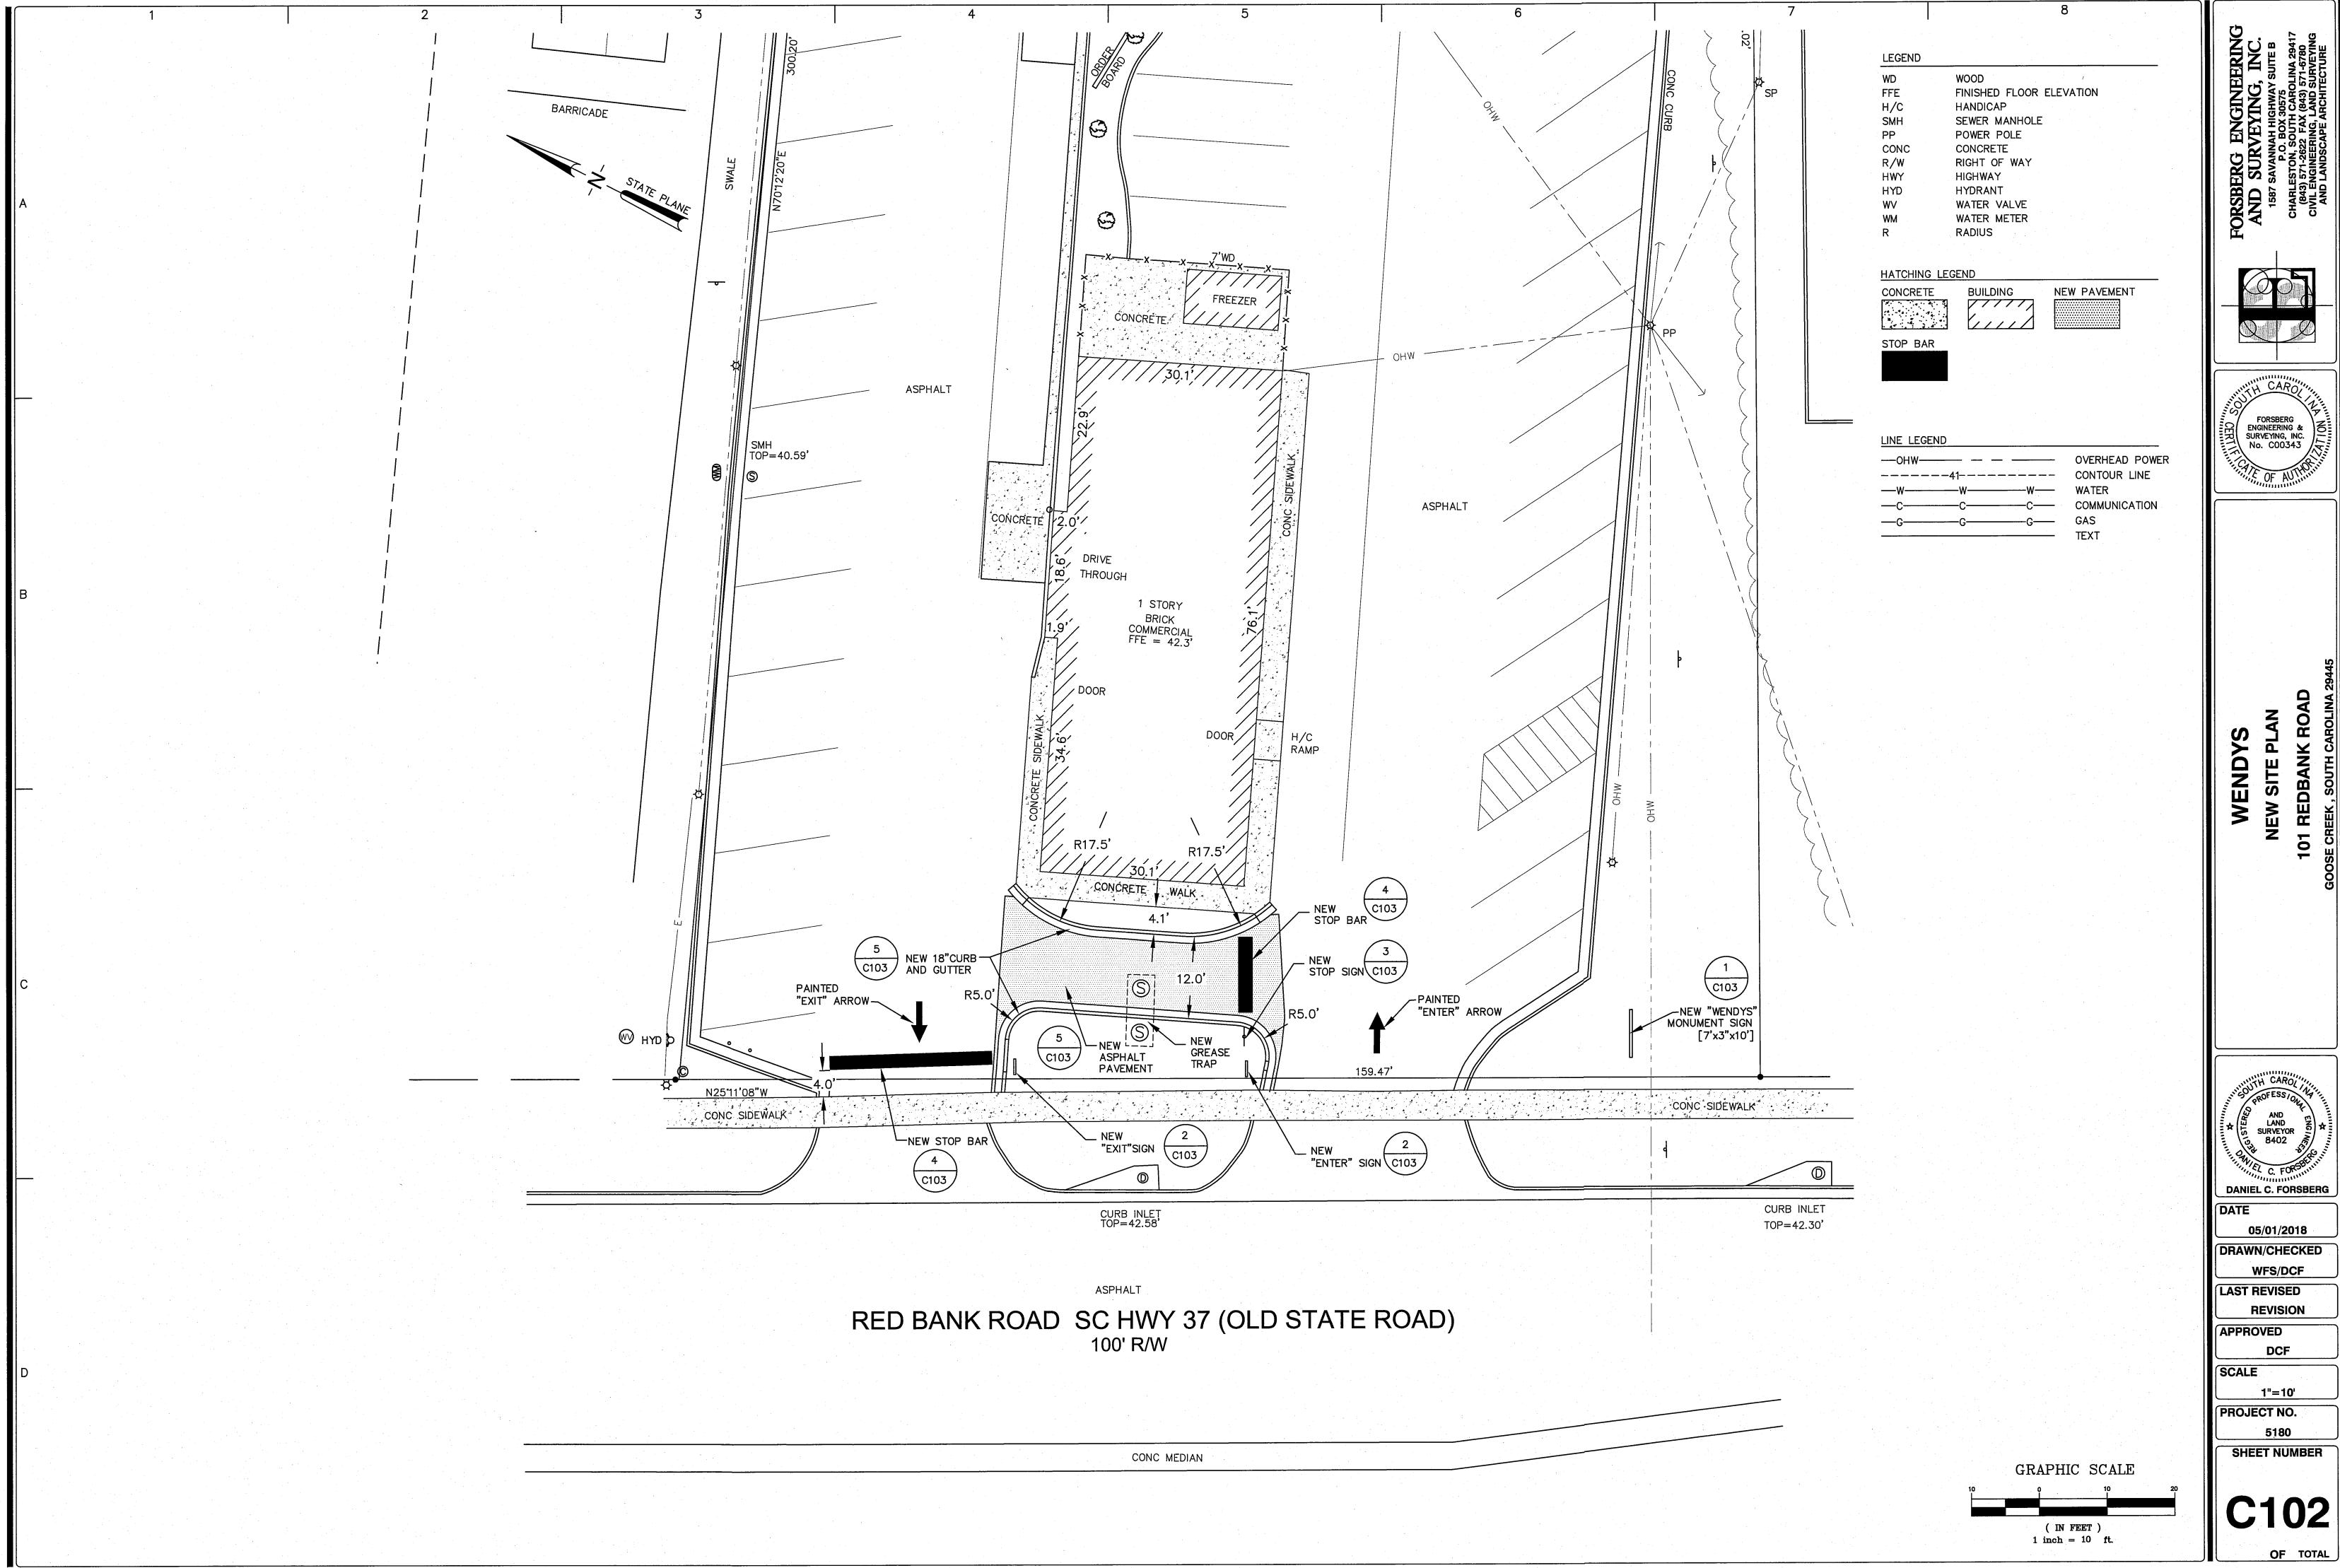


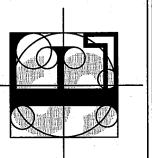


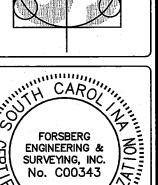

DANIEL C. FORSBERG

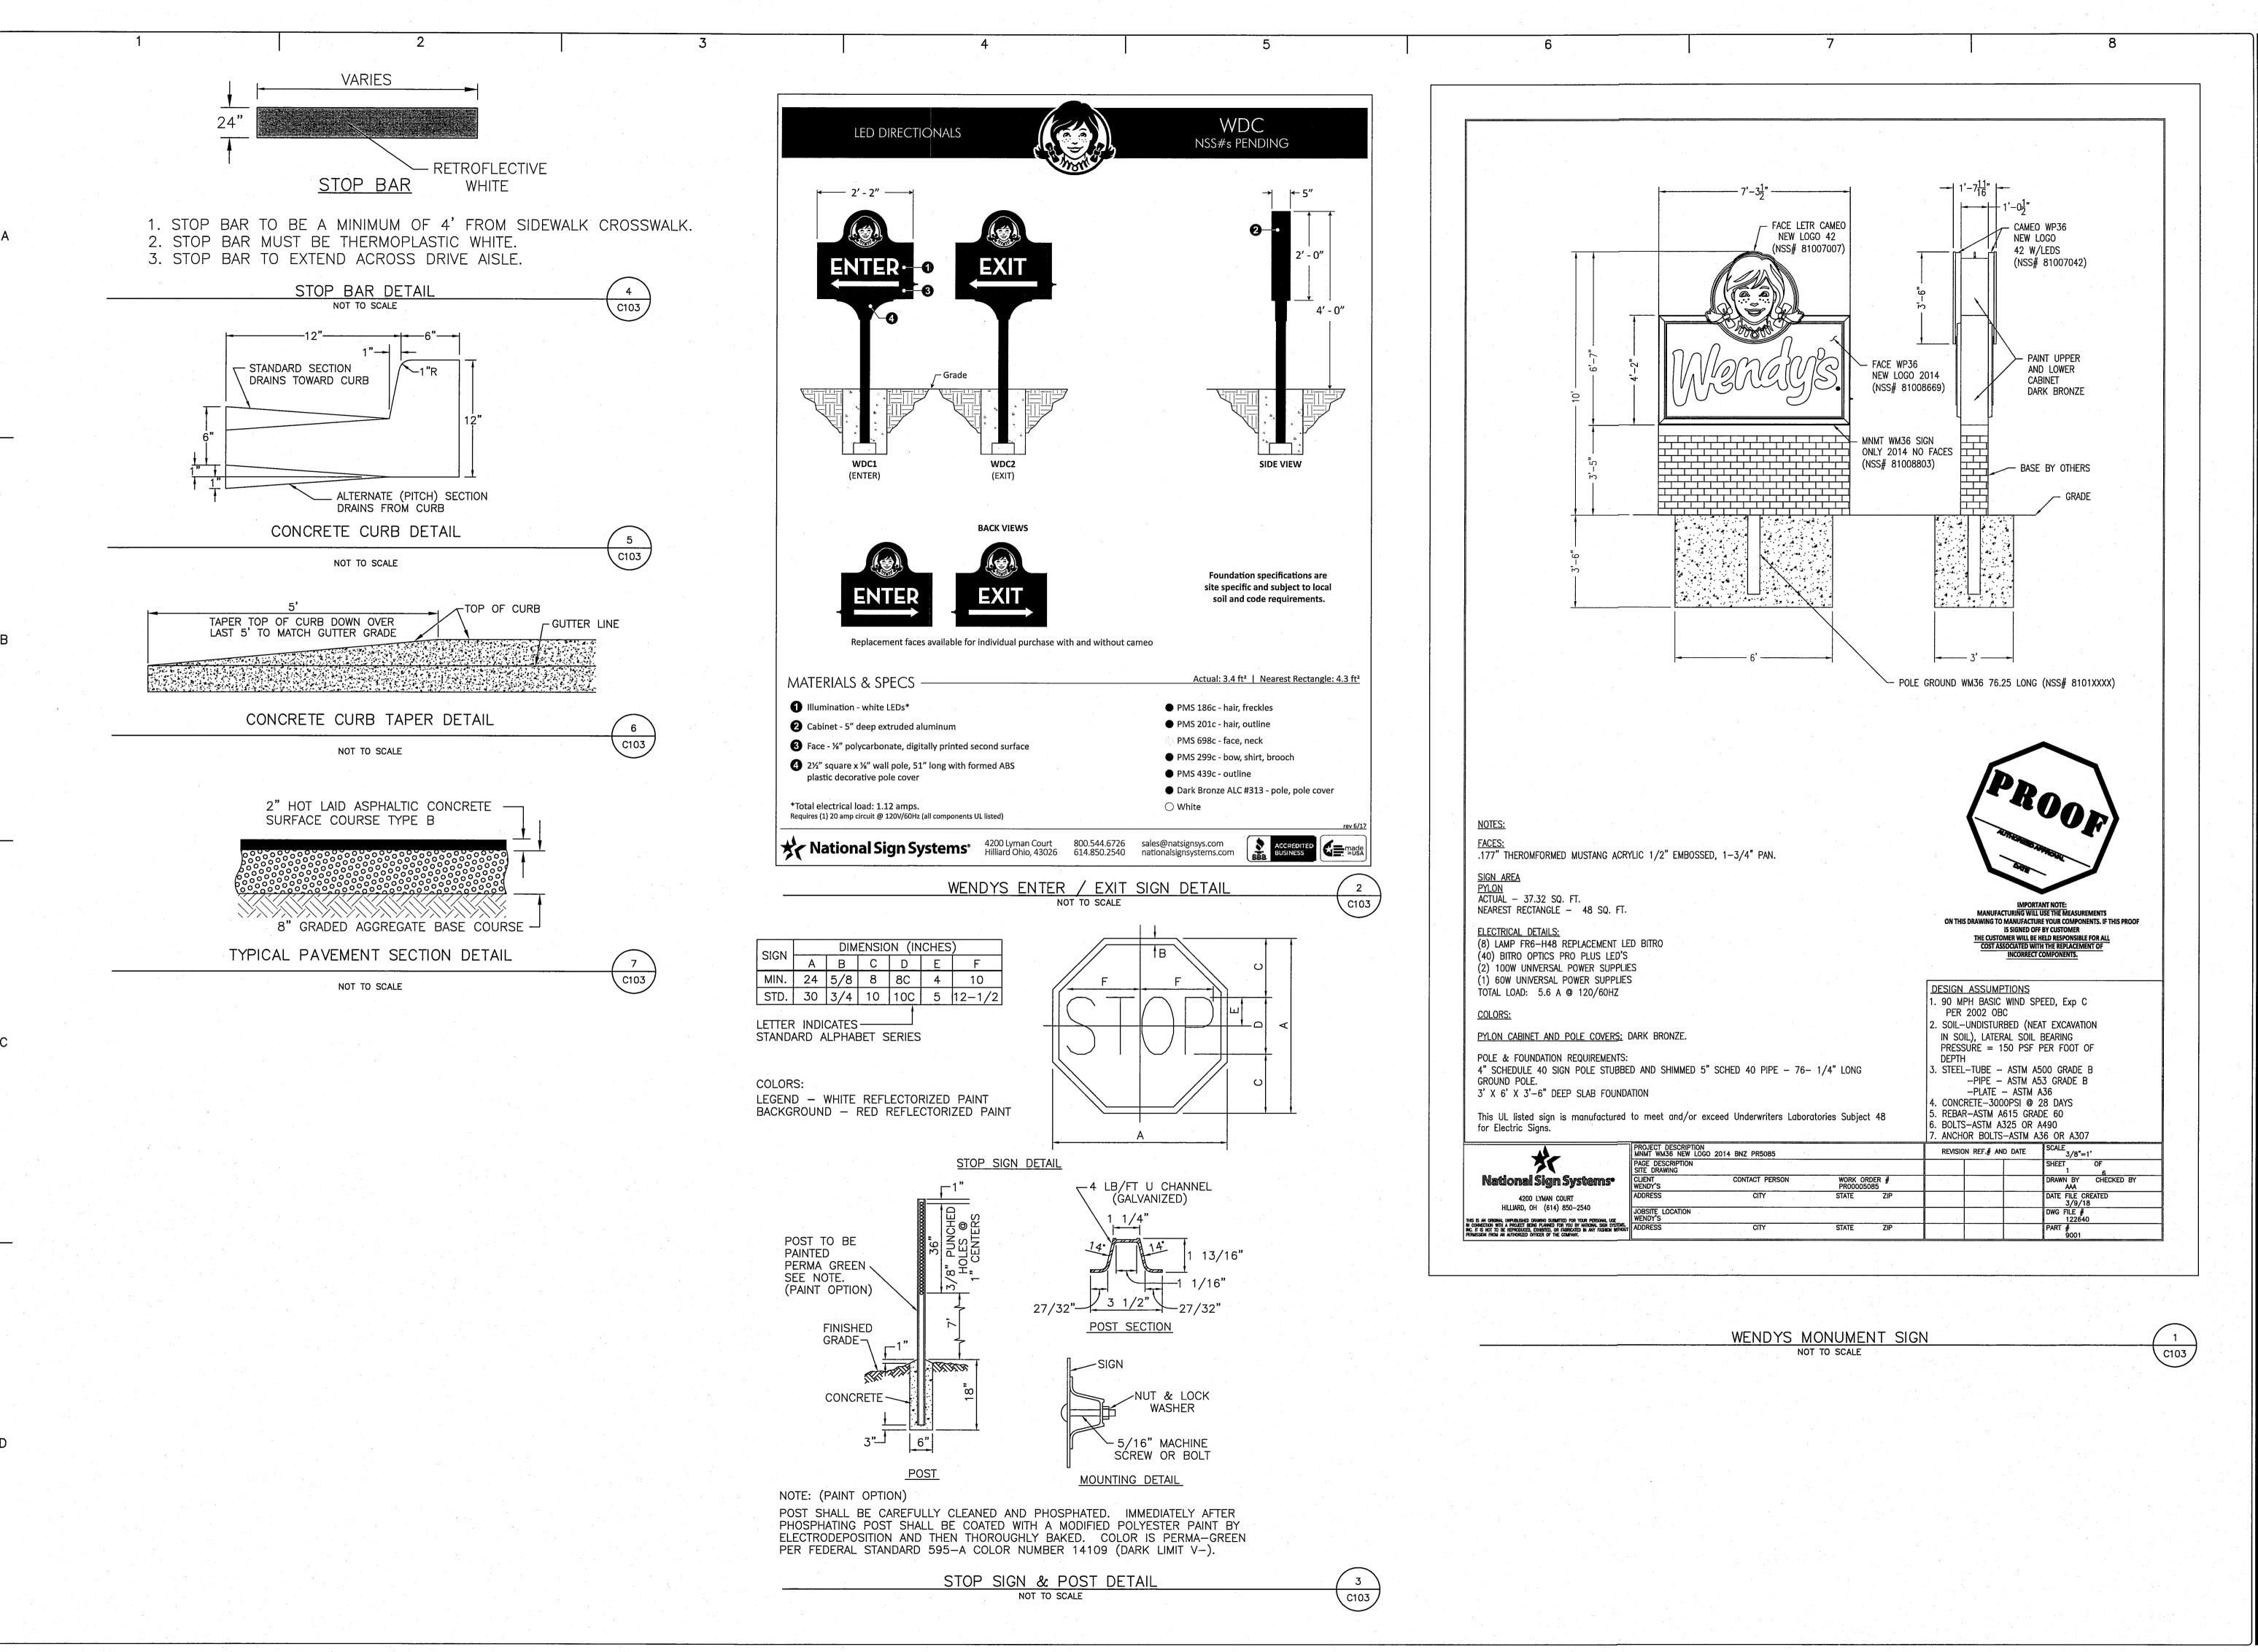

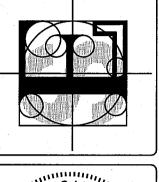

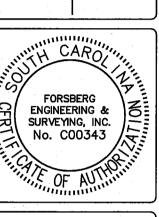

VENDY ONSTR 101

QOFESS/O AND LAND SURVEYOR 8402

DANIEL C. FORSBERG

05/01/2018 DRAWN/CHECKED WFS/DCF

LAST REVISED REVISION

APPROVED

DCF SCALE

N.T.S. PROJECT NO.

SHEET NUMBER

5180

OF TOTAL

