

# THE CITY OF GOOSE CREEK

BERKELEY CO. EST. 1961 SO. CAROLINA

ARCHITECTURAL REVIEW BOARD MONDAY, FEBRUARY 18, 2019 6:30PM

MARGUERITE BROWN MUNICIPAL CENTER
CITY HALL COUNCIL CHAMBERS
519 N. GOOSE CREEK BLVD.
GOOSE CREEK, SOUTH CAROLINA

### **MEMORANDUM**

**TO:** MEMBERS OF THE ARCHITECTURAL

**REVIEW BOARD** 

**FROM:** BRENDA M. MONEER

PLANNING TECHNICIAN

**DATE:** FEBRUARY 15, 2019

**SUBJECT:** NOTIFICATION OF ARB MEETING

This is to remind everyone that the next meeting of the Architectural Review Board is scheduled for Monday, February 18, 2019, at 6:30 p.m. at City Hall.

Should you have any questions or comments prior to Monday's meeting, please don't hesitate to contact myself (x.1116) or Daniel Moore, Interim Planning Director (x.1118) at 843-797-6220. We look forward to seeing you.



### CITY OF GOOSE CREEK

### ARCHITECTURAL REVIEW BOARD

### **AGENDA**

### **MONDAY, FEBRUARY 18, 2019, 6:30PM**

MARGUERITE BROWN MUNICIPAL CENTER
CITY HALL COUNCIL CHAMBERS
519 N. GOOSE CREEK BLVD.

I. CALL TO ORDER – Chairperson Sharon Clopton

II. ROLL CALL

III. **REVIEW OF MINUTES:** January 22, 2019

IV. NEW BUSINESS - Minor Applications

A. Roper Medical Center - SignageB. Pinnacle 1 Goose Creek - Signage300 Red Bank Rd.

V. OLD BUSINESS – Major Applications

C. Goose Creek Villages Plantation North Blvd.

VI. NEW BUSINESS – Major Applications

D. Fresenius – Waters Creek Baxter Brown Way

• Site, Landscape, Elevations, Materials, Colors

E. Hire Quest – Crowfield Plantation 111 Springhall Dr.

Site, Landscape, Elevations, Materials, Colors

F. Southern Twist 117 S. Goose Creek Blvd.

• Parking Lot, Dumpster Enclosure, Landscaping

VII. COMMENTS FROM THE BOARD

VIII. COMMENTS FROM STAFF

IX. ADJOURNMENT

### ARCHITECTURAL REVIEW BOARD SIGN FORM

ARB MEETING DATE: FEBRUARY 18, 2019

BUSINESS NAME: PINNACLE 1 GOOSE CREEK

LOCATION: 300 RED BANK ROAD
NUMBER & TYPE OF SIGNS APPLYING FOR:

Number & Type of Signs Applying for Number of Allowable Signs:

MAXIMUM ALLOWABLE SIGN AREA:



1 WALL MOUNT, 1 FREESTANDING 2 WALL MOUNT, 2 FREESTANDING 33 SF – APPLICABLE SIGN FACE

### **GENERAL INFORMATION:**

SIGN	SIGN 1	SIGN 2	SIGN 3	SIGN 4	
TYPE (W= WALL-MOUNTED/F=FREESTANDING)	F	W			
Неіднт	4'-0"	1'-1"			
WIDTH	7'-0"	4'-6"			
Area	28 SF	4.87 SF			
Color	Red/white/blue	Red/white/blue/tan			
Materials	Alum./Steel/Acrylic	Alum./composite			
SIZE OF GRAPHIC	8 SF within sign face	13SFwithin sign face			
Is it Illuminated?	Internal	No			


### ONLY APPLICABLE TO WALL-MOUNTED SIGNS:


REFERENCE SIGN # (FROM ABOVE)	SIGN 1	SIGN 2	SIGN 3	SIGN 4	
FRONT LINEAR FRONTAGE OF BUSINESS		33'			
DISTANCE FROM BUSINESS TO PROPERTY LINE		54'			
TOTAL NUMBER OF LETTERING STYLES		2			
SPACE BETWEEN LETTERS (FOR CHANNEL LETTERS)		N/A			
SPACE BETWEEN WORDS (FOR CHANNEL LETTERS)		N/A			
HEIGHT OF LETTERS		N/A			
PROJECTION FROM WALL		1/4"			

### ONLY APPLICABLE TO FREESTANDING SIGNS:

JNLY APPLICABLE TO FREESTANDING	SIGNS:				
REFERENCE SIGN # (FROM ABOVE)	SIGN 1	SIGN 2	SIGN 3	SIGN 4	
DISTANCE FROM STREET CURB	To Verify with County				
HEIGHT ABOVE GRADE	7'-0"				
BASE LANDSCAPING	NONE				
LANDLORD APPROVAL LETTER RECEIVED		YES	⊠ No	N/A	
PERMIT PAID		XES YES	□No	N/A	
SAMPLE MATERIALS ATTACHED		□ Y <sub>ES</sub>	No	N/A	

CITY OF GOOSE CREEK DEPARTMENT OF PLANNING AND ZONING • 519 N. GOOSE CREEK BOULEVARD• GOOSE CREEK, SC 29445 • (843) 797-6220 • WWW.CITOFGOOSECREEK.COM

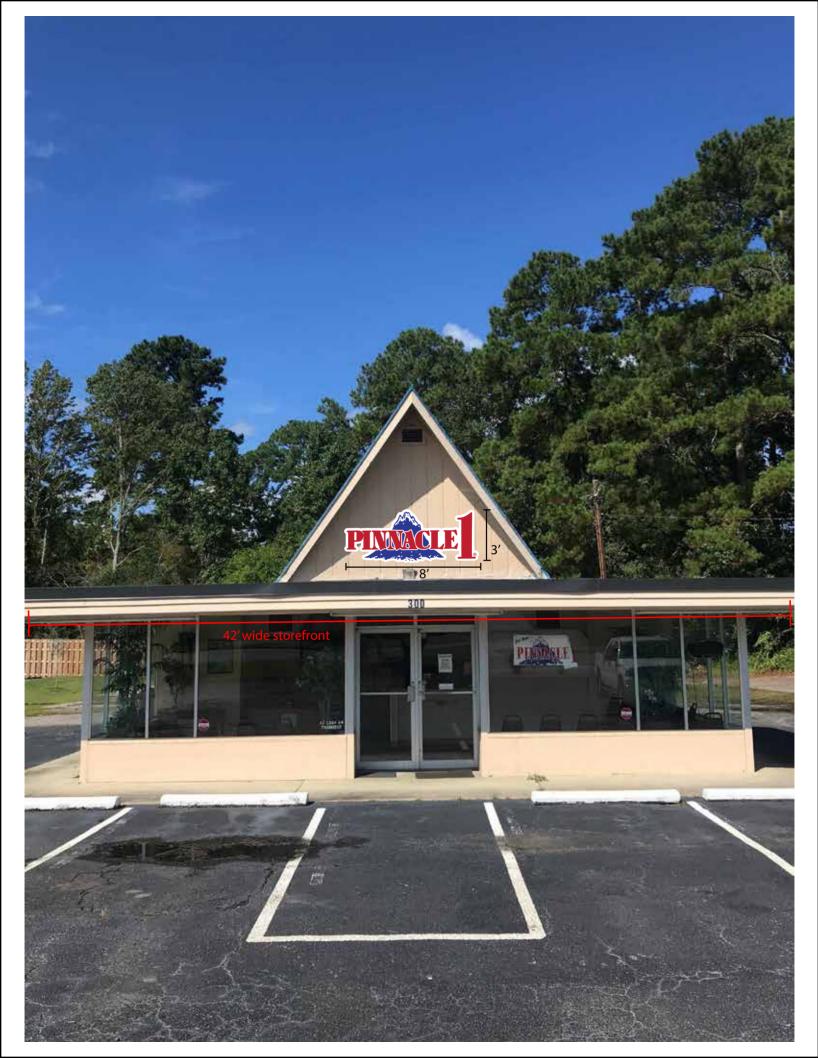

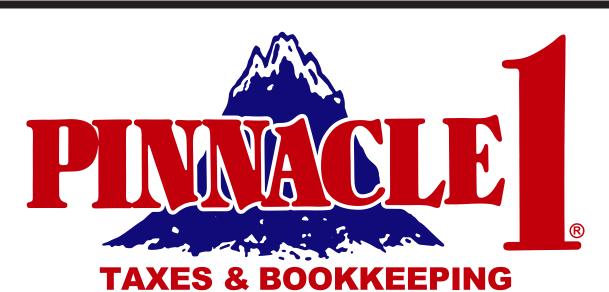

Serving Goose Creek Since 2003

843-797-5185

7′

3'

4'

### ARCHITECTURAL REVIEW BOARD SIGN FORM

ARB MEETING DATE: FEBRUARY 18, 2019

BUSINESS NAME: ROPER MEDICAL CENTER

LOCATION: 149 St. James Ave.

Number & Type of Signs Applying For:

NUMBER OF ALLOWABLE SIGNS: MAXIMUM ALLOWABLE SIGN AREA: 2 WALL MOUNT, 1 FREESTANDING 3 WALL MOUNT, 2 FREESTANDING 167 SF - APPLICABLE SIGN FACE

### **GENERAL INFORMATION:**

SIGN	SIGN 1	SIGN 2	SIGN 3	SIGN 4	
ТүрЕ					
(W= WALL-MOUNTED/F=FREESTANDING)	F	W	W		
Неіднт	8'-0"	1'-1"	3'-0"		
Width	3'-10"	4'-6"	8'-0"		
AREA	30.66 SF	4.87 SF	24 SF		
Color	Black/Cream	Red/Black	Black/White		
MATERIALS	¾" Mdo Ply	3/4" Mdo Ply	¾" Mdo Ply		
SIZE OF GRAPHIC	N/A	8" dia.	N/A		
IS IT ILLUMINATED?	No	No	No		

### ONLY APPLICABLE TO WALL-MOUNTED SIGNS:

REFERENCE SIGN # (FROM ABOVE)	SIGN 1	SIGN 2	SIGN 3	SIGN 4	
FRONT LINEAR FRONTAGE OF BUSINESS		111'	111'		
DISTANCE FROM BUSINESS TO PROPERTY LINE		144'	144'		
TOTAL NUMBER OF LETTERING STYLES		1	1		
SPACE BETWEEN LETTERS (FOR CHANNEL LETTERS)		N/A	N/A		
SPACE BETWEEN WORDS (FOR CHANNEL LETTERS)		N/A	N/A		
HEIGHT OF LETTERS		N/A	N/A		
PROJECTION FROM WALL		N/A	N/A		

JNLY APPLICABLE TO FREESTANDING SIGNS:									
REFERENCE SIGN # (FROM ABOVE)	SIGN 1	SIGN 2	SIGN 3	SIGN 4					
DISTANCE FROM STREET CURB	5' +/- (INT. OF LOT)								
HEIGHT ABOVE GRADE	8'-0"								
BASE LANDSCAPING	NONE								
LANDLORD APPROVAL LETTER RECEIV	YES	⊠ No	N/A						
PERMIT PAID		XES YES	□No	N/A					
SAMPLE MATERIALS ATTACHED		☐ YES	⊠ No	N/A					

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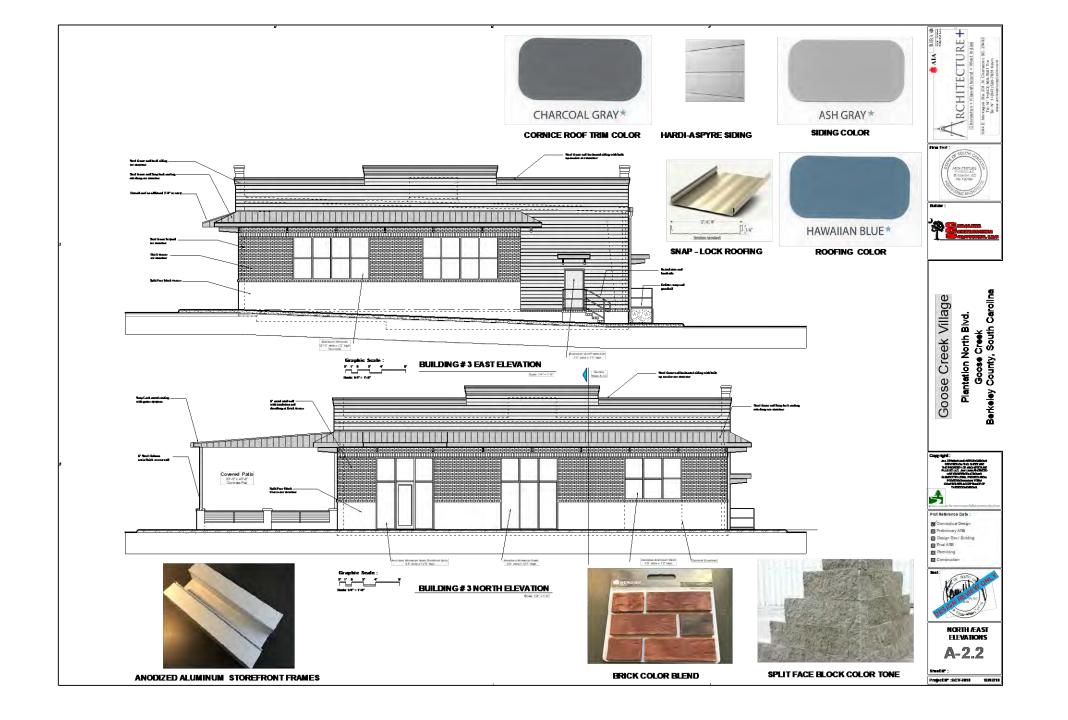















# FRESENIUS APPLICATION AGENDA ITEM D.

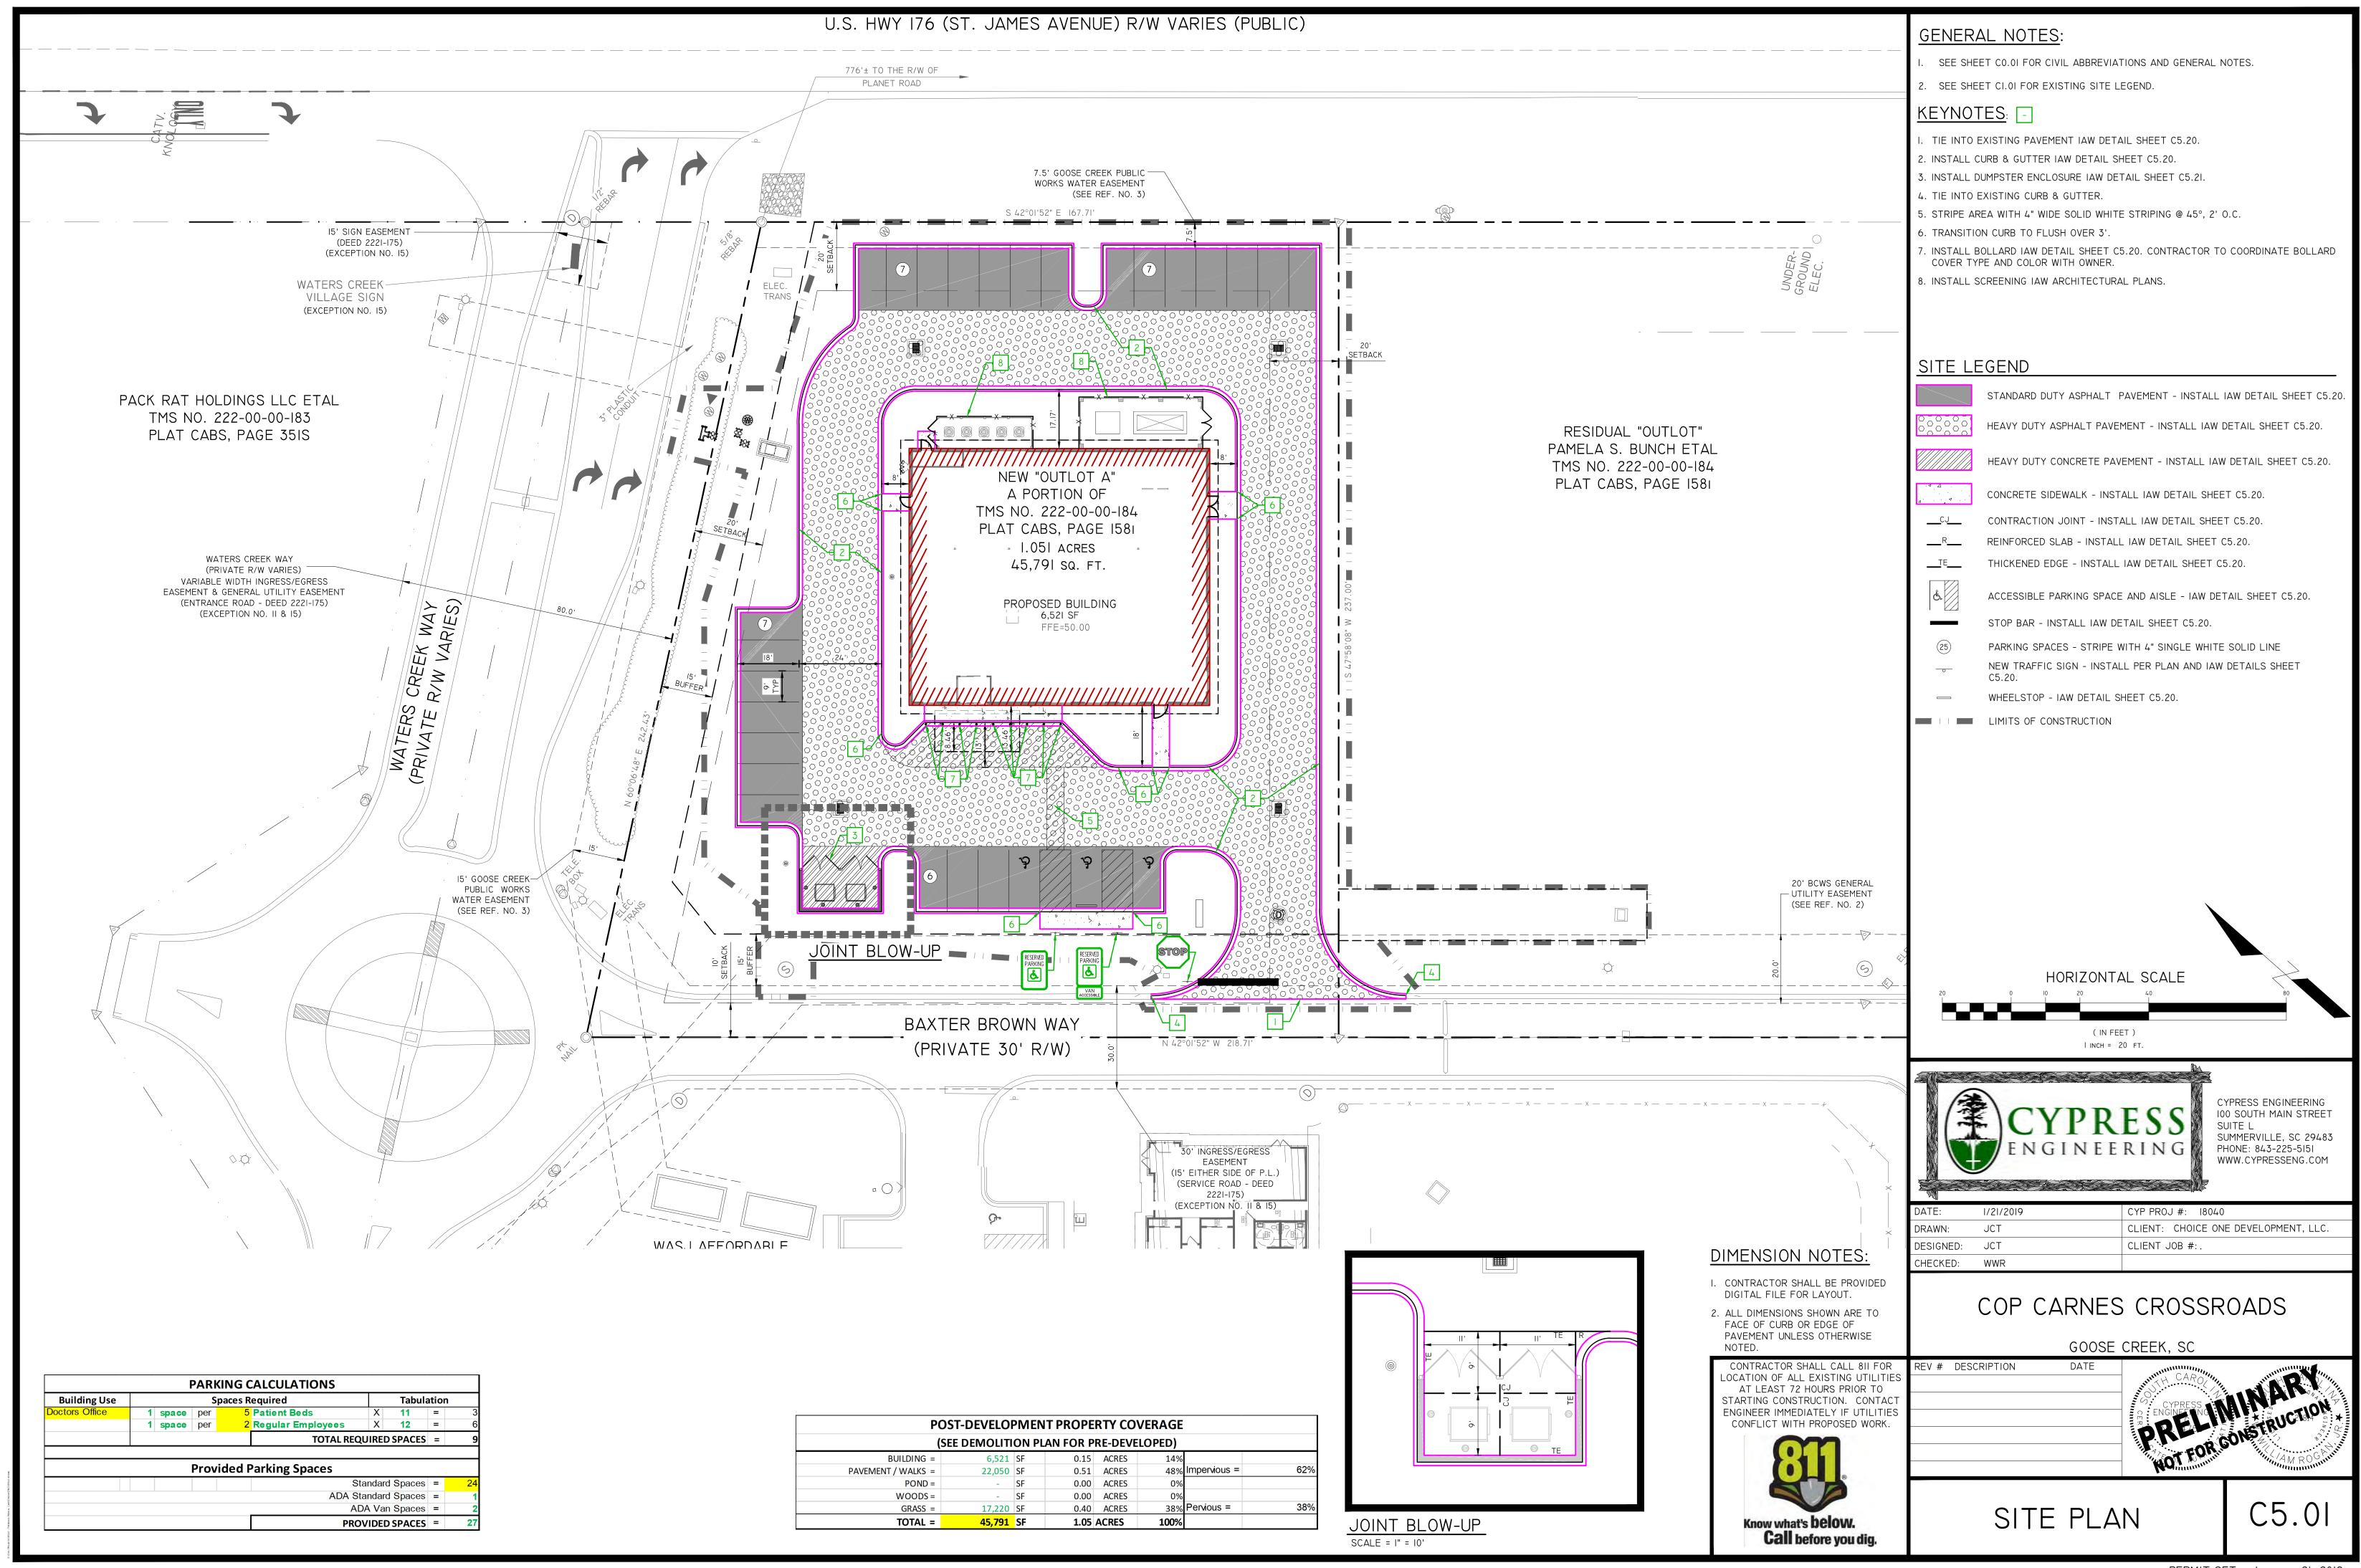

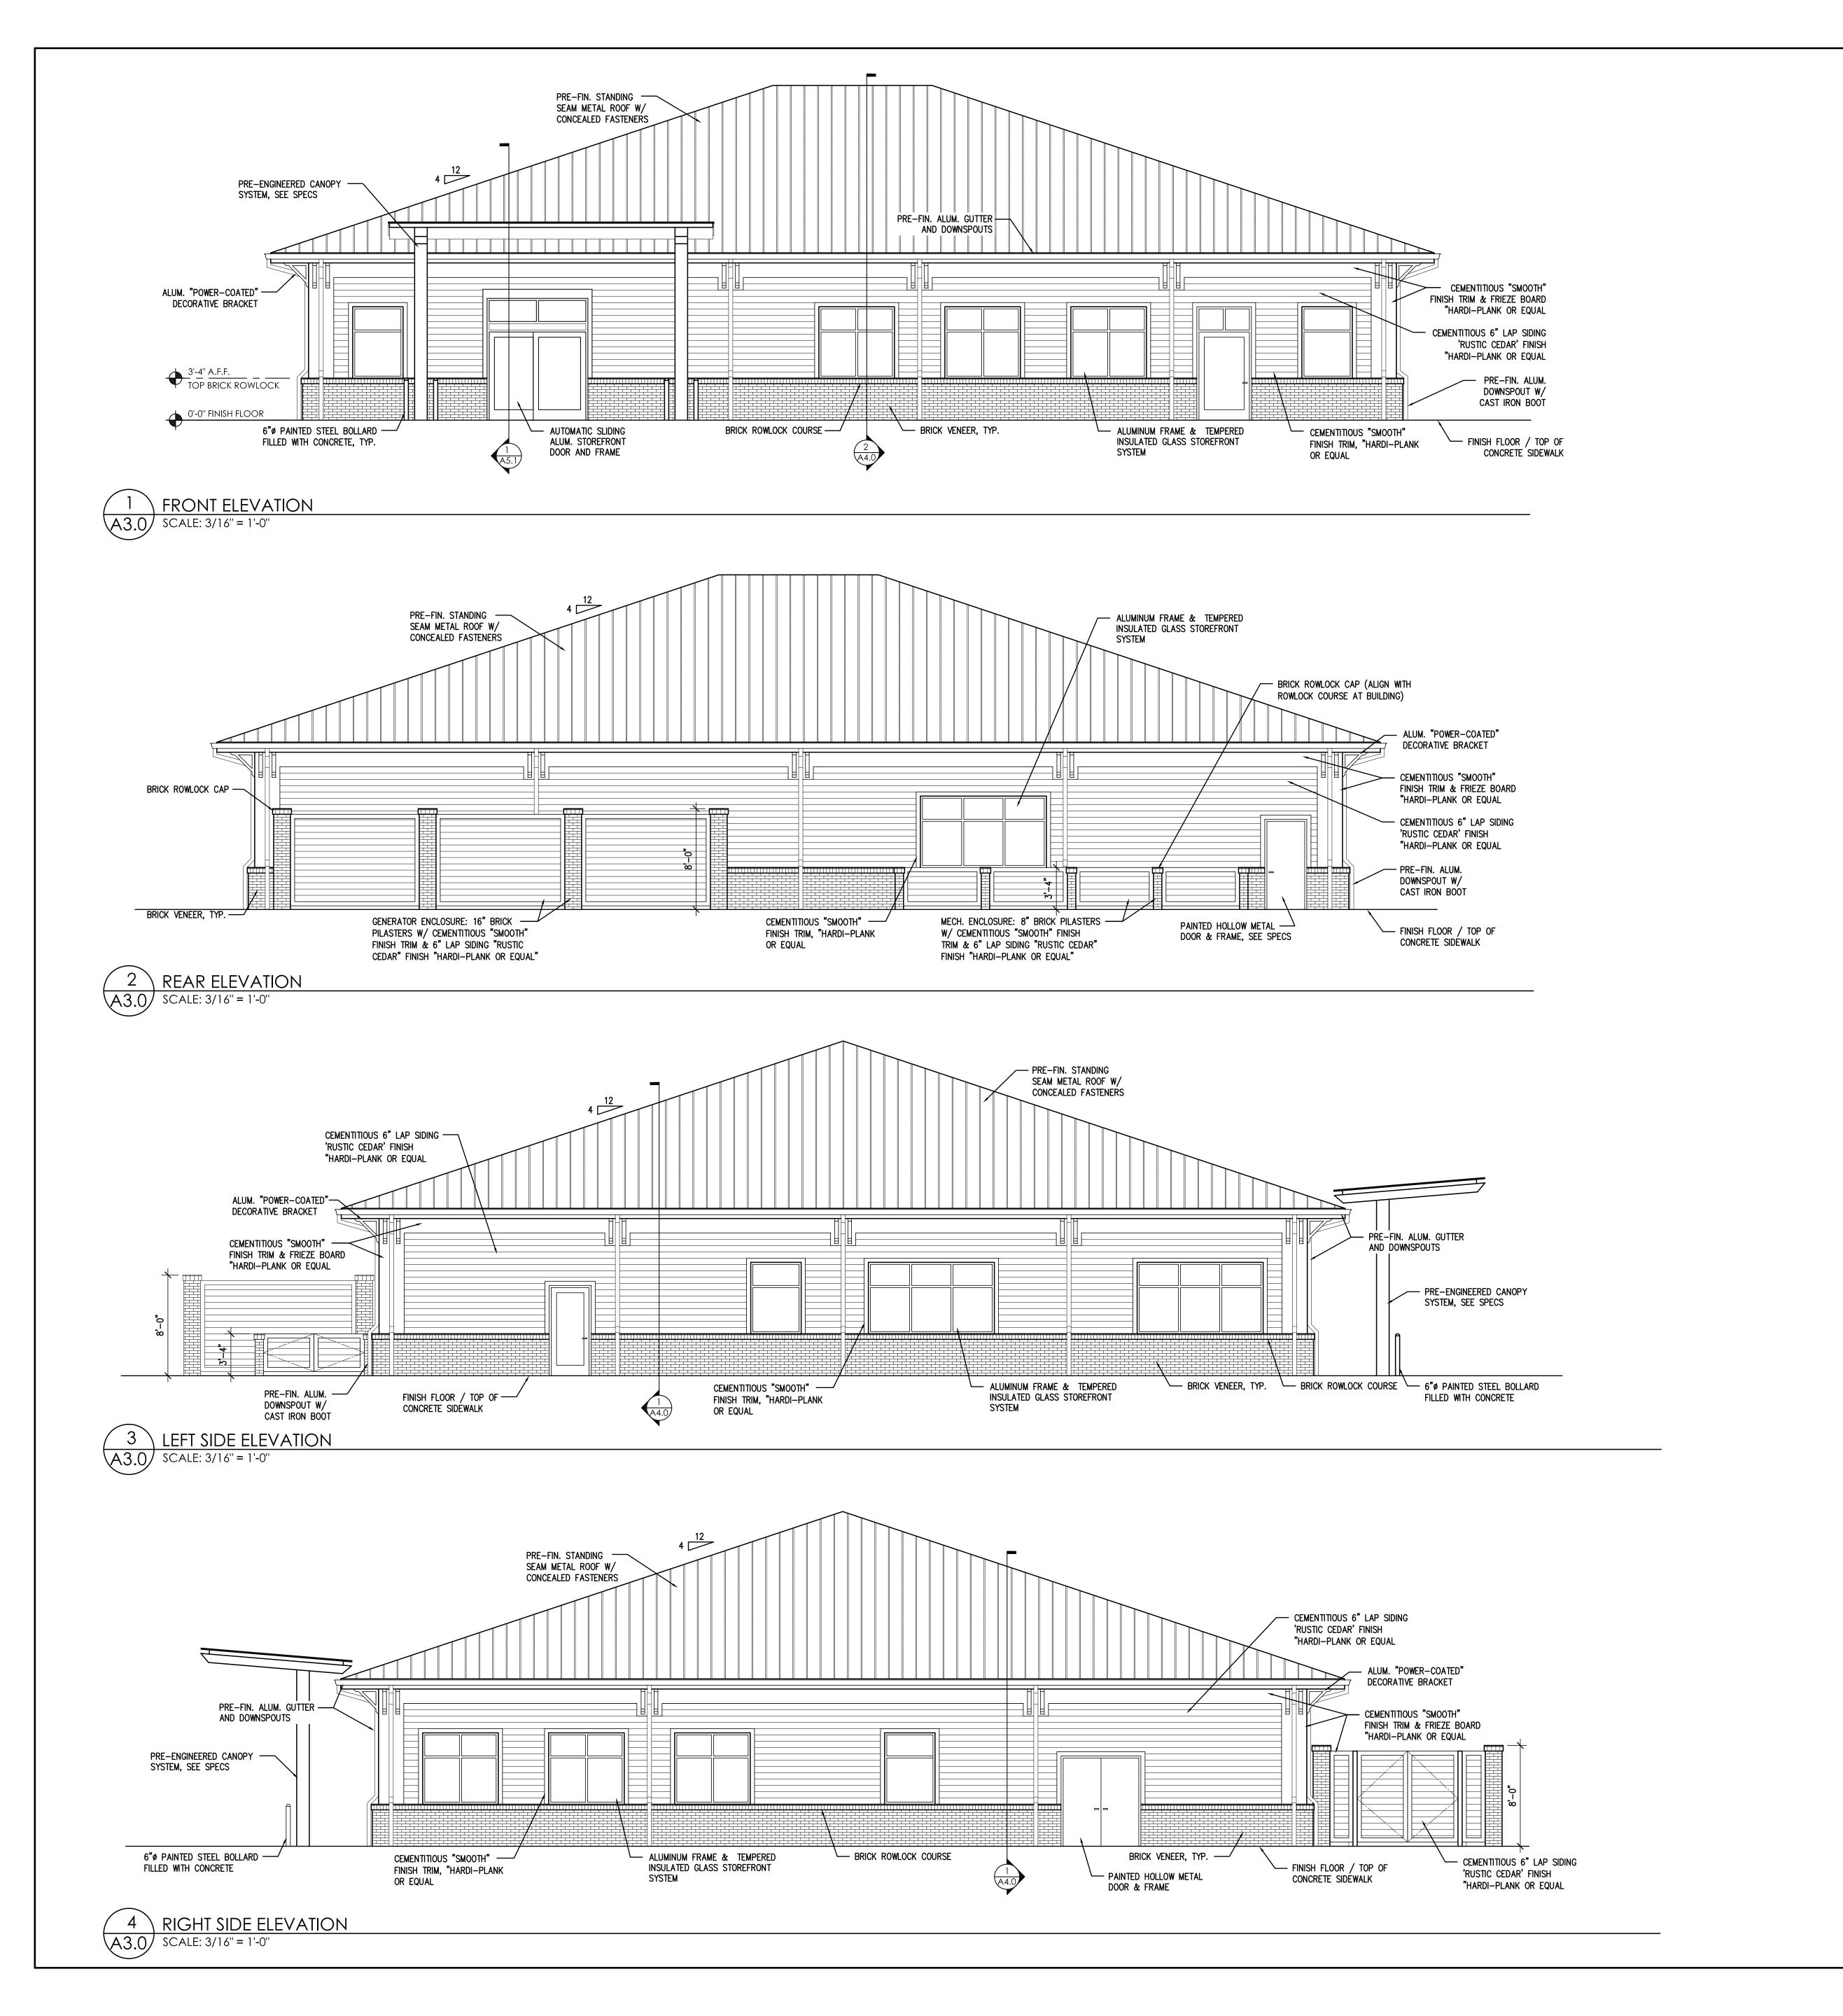

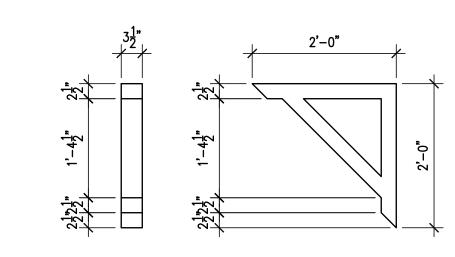

5 DECORATIVE BRACKET DETAIL
A3.0 SCALE: 3/4" = 1'-0"

DUNN &
DALTON
ARCHITECTS
401 North Herritage St.
Kinston, NC 28501
252-527-1523 phone
252-527-0049 fax

OSSROADS J-2017

Proposed Shell Building for:

FKC CARNES CROSSF
100405-1-DN-E-GU-201

FRESENT


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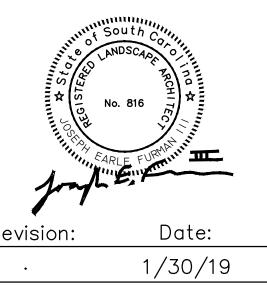
Sheet Number

EXTERIOR ELEVATIONS

SCALE: 3/16" = 1'-0"





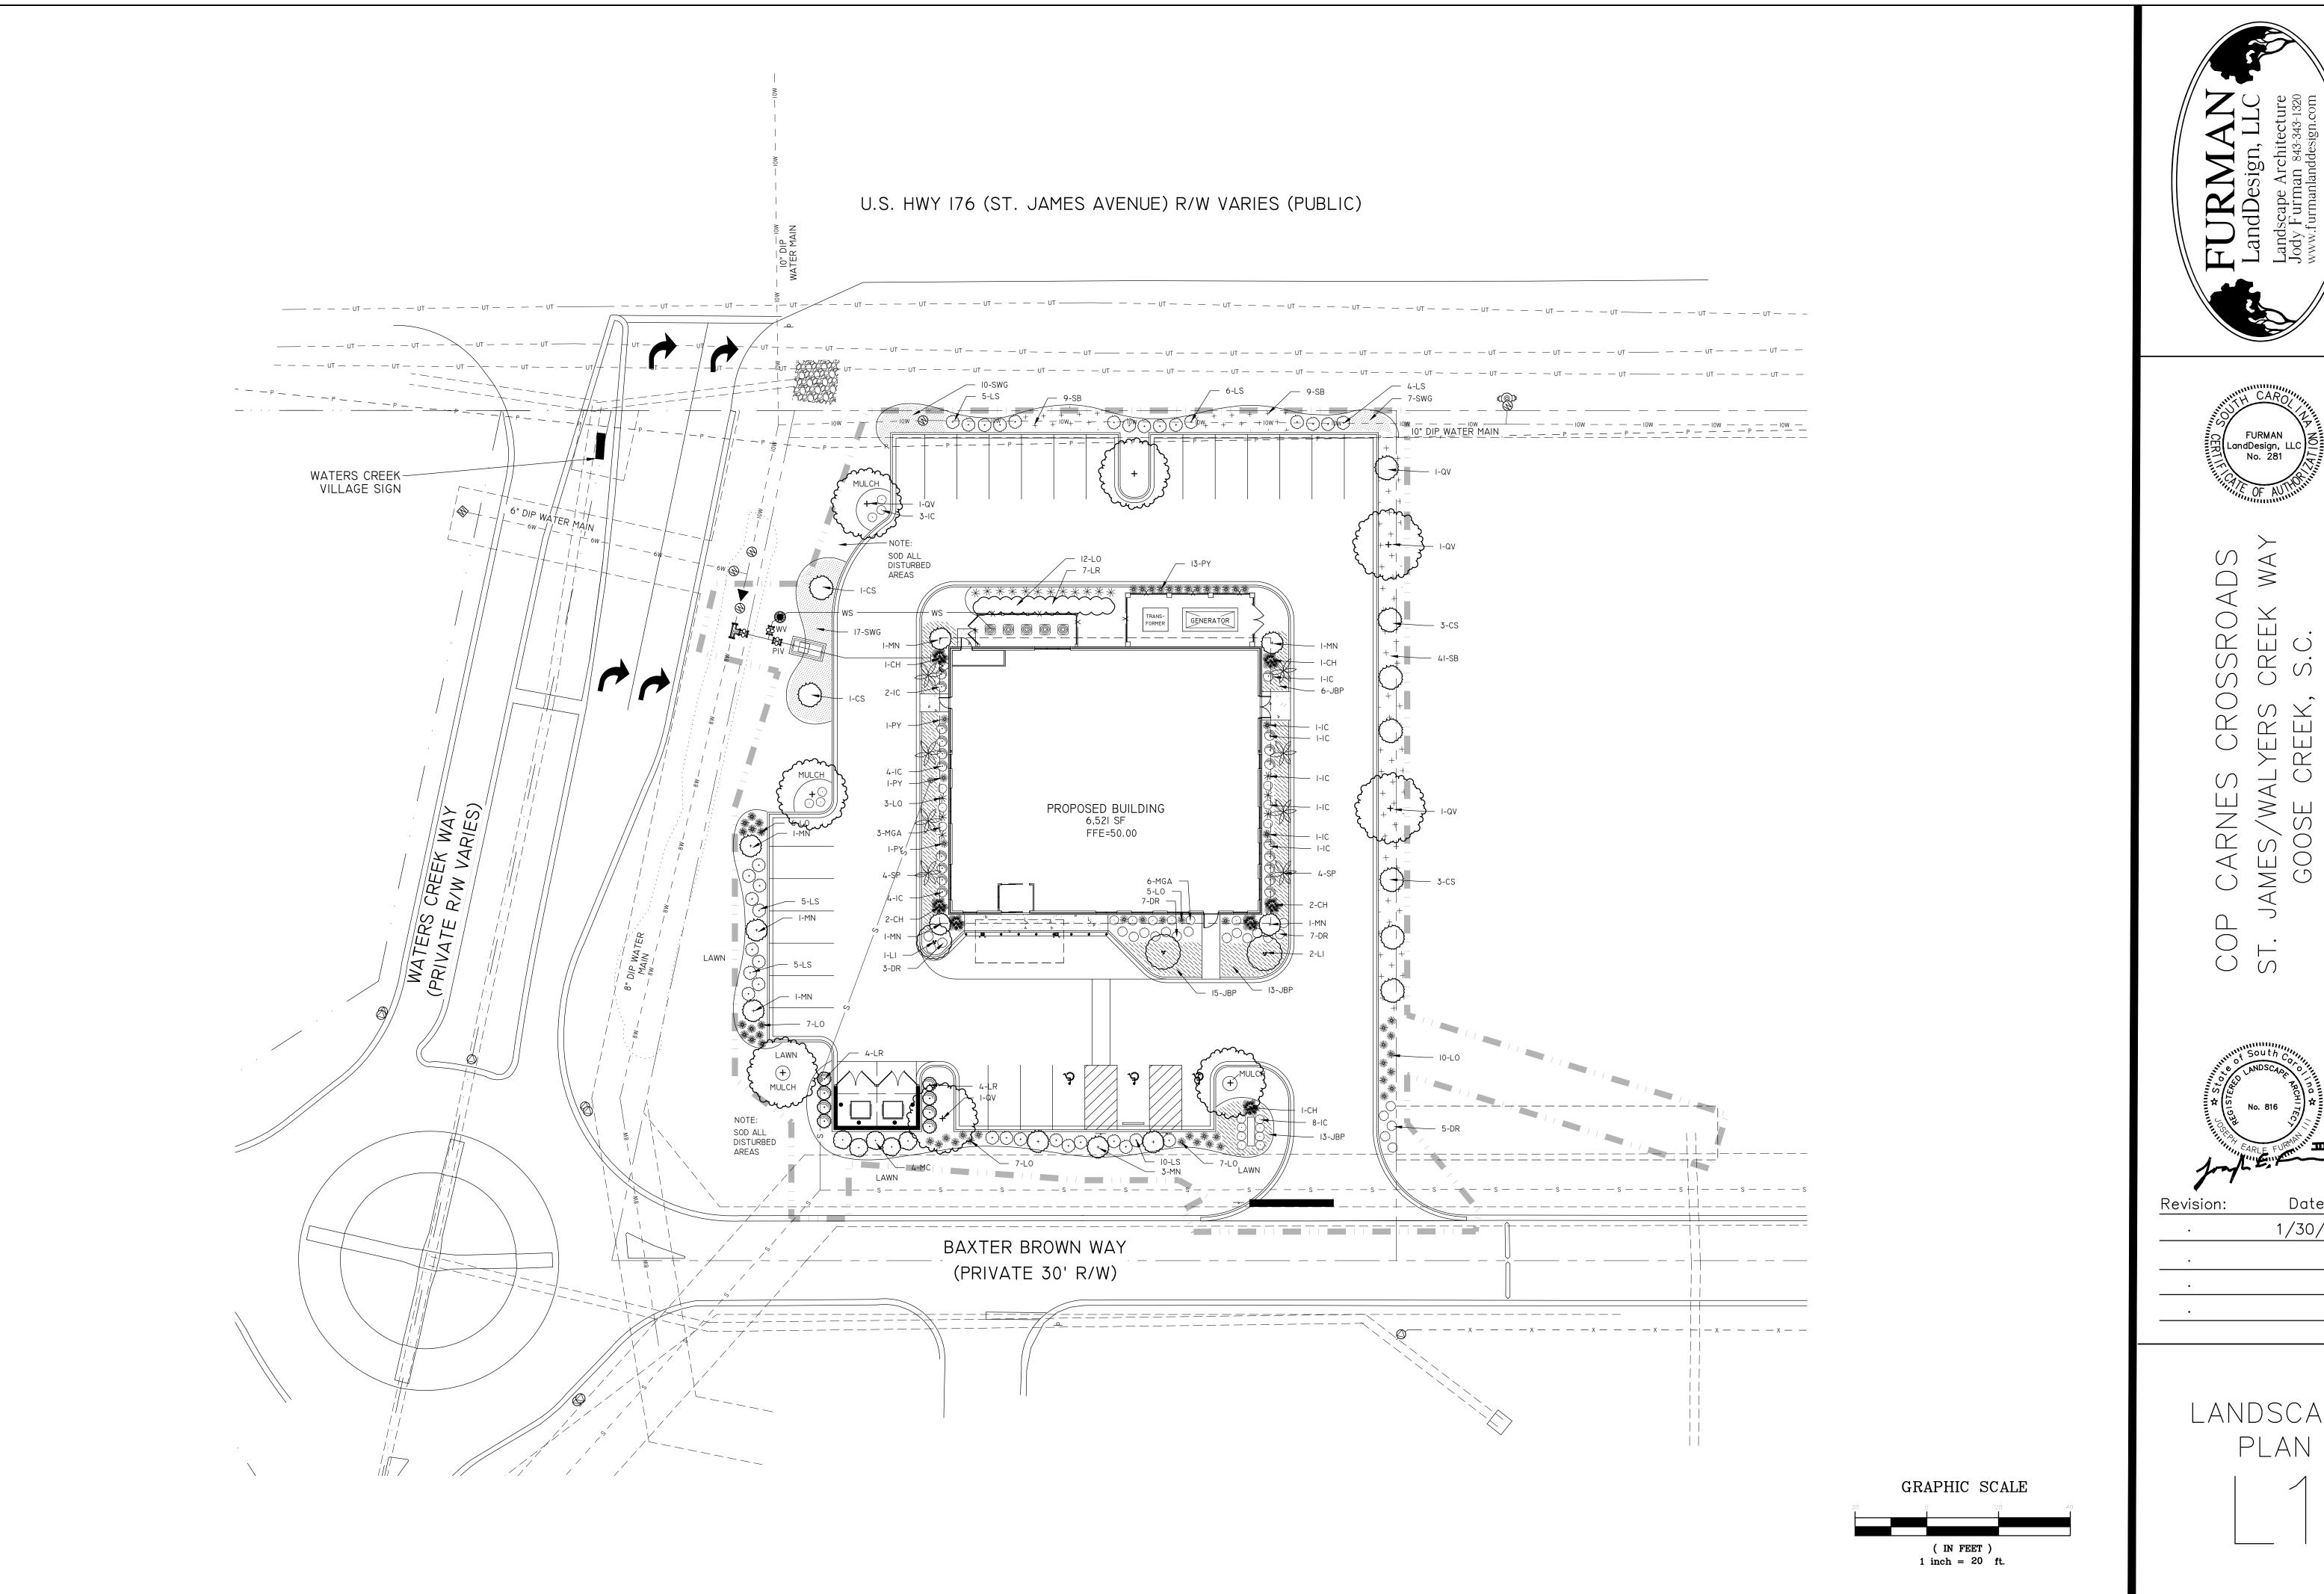

LANDSCAPE PLAN



### Architectural Review Board

### **APPLICATION / INFORMATION SUMMARY**

### DEPARTMENT OF PLANNING AND ZONING 843-797-6220 EXT. 1118

P.O. Drawer 1768


519 N. Goose Creek Blvd.

Goose Creek, South Carolina 29445-1768


www.cityofgoosecreek.com

Fax: 843-863-5208

Property Address:	111 Springhall Drive		TMS No.:	243-03	-00-023	3 & 03 <sup>-</sup>	1
Review request: For:				Preliminary meeting date requested:			
X Conceptual	■New Construction □ Alterations / Additions			Decision o	of Architec	ctural Rev	view Board
☐Preliminary ☐ Final	☐Repairs or repaint with no changes		□Color C	hange $\square$	Demolitic	on	
Property Owner:	Hire Quest	Dayti	me phone:	843.72	23.7400	0	
Applicant:	John B. Crouch III, Architect	Dayti	me phone:	843.27	70.2976	6	
ARB Meeting Representative	Applicant	Cont	act Informa	tion :			
Applicant's mailing address:	666 Harbor Creek Place						
City:	Charelston	State	SC	Zip:	29412	2	
Applicant's e-mail address:	John@OceanaDesignLLC.com						
Applicant's relationship:	□Owner <b>X</b> Design Professional □	Contra	ctor 🔲	RealEstate	Agent/Br	roker	Other
Materials/Colors (	Used: (specific color(s)/manufacture #'s listed: s (Example: Building Materials, Exterior Col	•	•		o Board	Xattac	thed)
	Brick to Match Existing  Dark Bronze Anodized Aluminum to Match	Existin	na .				
	Aluminum Gutters & Parapet Caps to match		-	one			
-	Ok. Bronze Aluminum to match Existing Ok. Bronze Aluminum to match Existing						
	Elear Satin Anodized Aluminum						
Glazing: (	Clear, Non-reflective Insulated Glazing						
	Scope of Work: (please give a de	etailed	description	)			
	Building, Adjacent but not attached to an e				Ptormuso.	tor man	agament Cita
Lighting, & Signage.	construction of the building and associated	, Diive	s, waiks,	raiking, s	olomiwa	ter man	agement, Site
	a 2 Story structure 9,000 SF Total Area						
First Floor Area: 6.000 Second Floor Area, 3,0							
	(Matched that Existing)						
the subject property or an au	y signature below that the foregoing application is uthorized representative. I authorize the subject pr ural Review Board of the City of Goose Creek on t	operty	to be poste				
Applicant's signature:	J9300	vc	<u></u>		Date:	1.17	.19
Print name legibly:	John B. Crouch III						

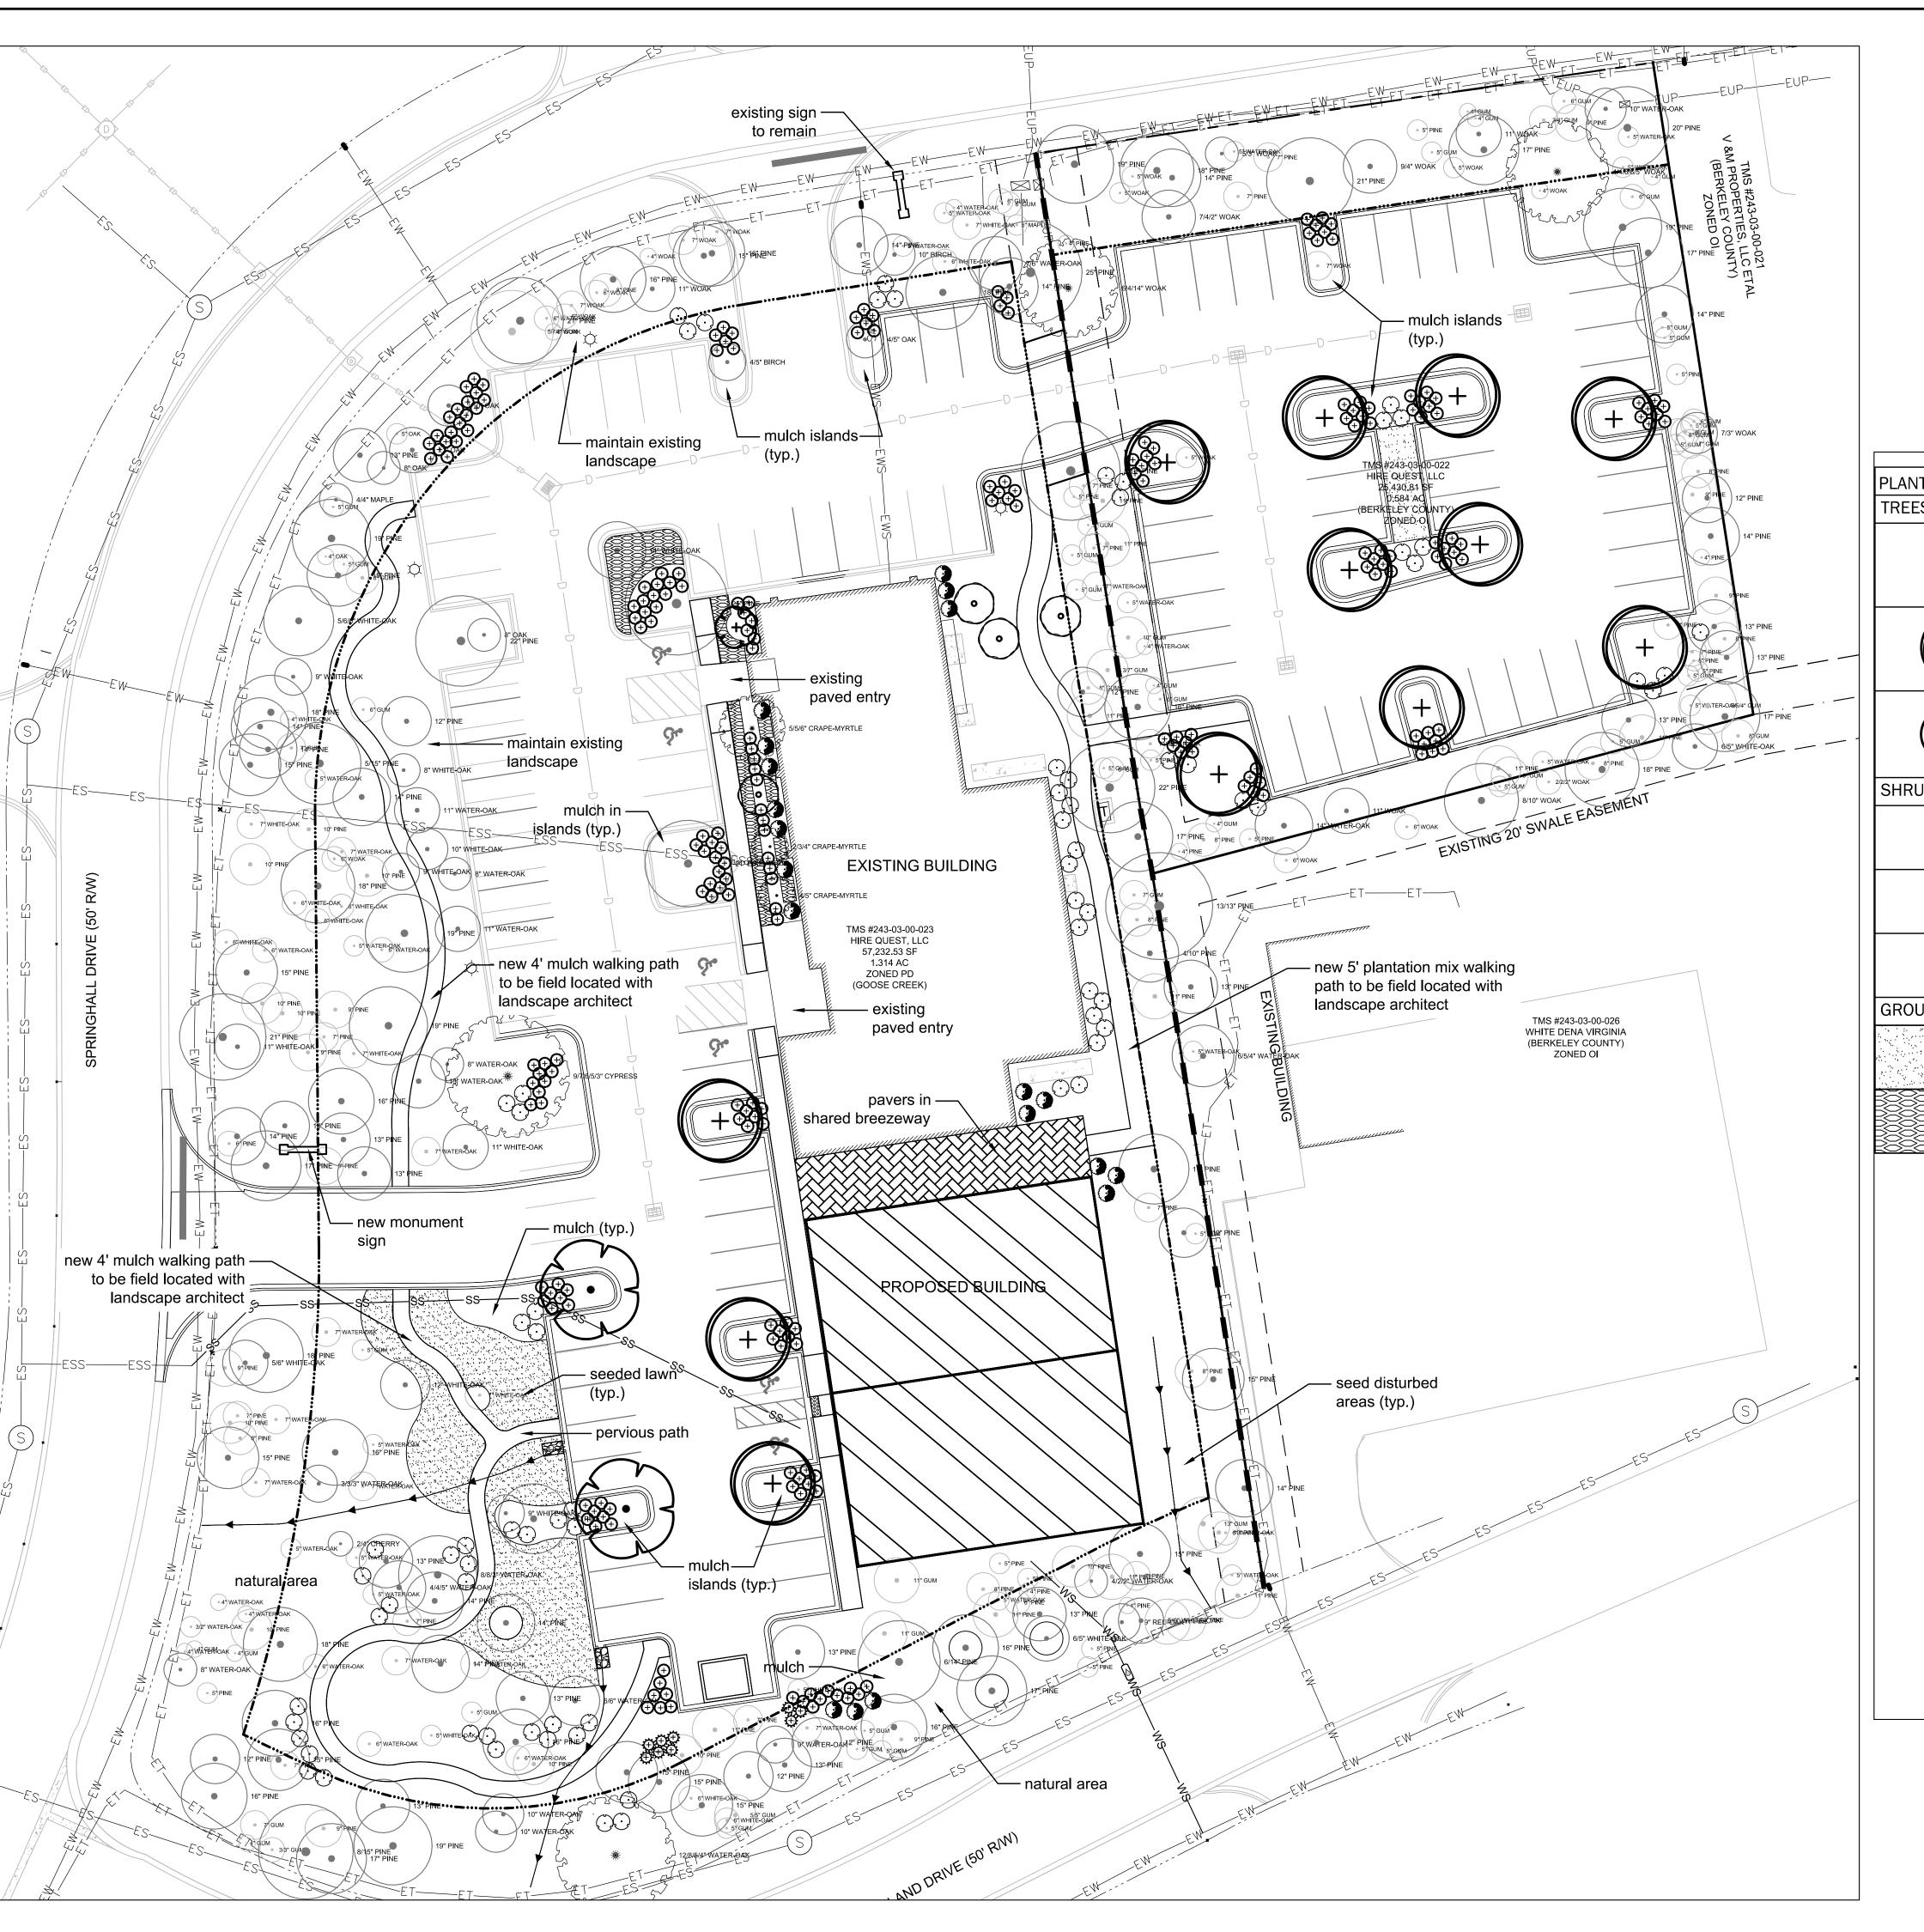

PLANT SCHEDULE		
TREES	CODE	BOTANICAL NAME / COMMON NAME
•	LAIN3	Lagerstroemia x `Natchez` / Natchez Crape Myrtle
+	QUEV	Quercus virginiana / Southern Live Oak
	QUEV-4	Quercus virginiana / Southern Live Oak
SHRUBS	CODE	BOTANICAL NAME / COMMON NAME
€ · d	AZAM3	Azalea indica `Mrs. G.G. Gerbing` / Mrs. G.G. Gerbing Azalea
(+)	LCRR3	Loropetalum chinense rubrum `Ruby` / Dwarf Ruby Fringe Flow
	VIBS2	Viburnum suspensum / Sandankwa Viburnum
GROUND COVERS	CODE	BOTANICAL NAME / COMMON NAME
	SOD2	Cynodon dactylon / Bermuda Grass
	TRAA	Trachelospermum asiaticum `Asiatic` / Asiatic Jasmine

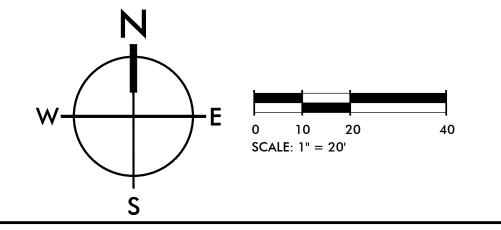



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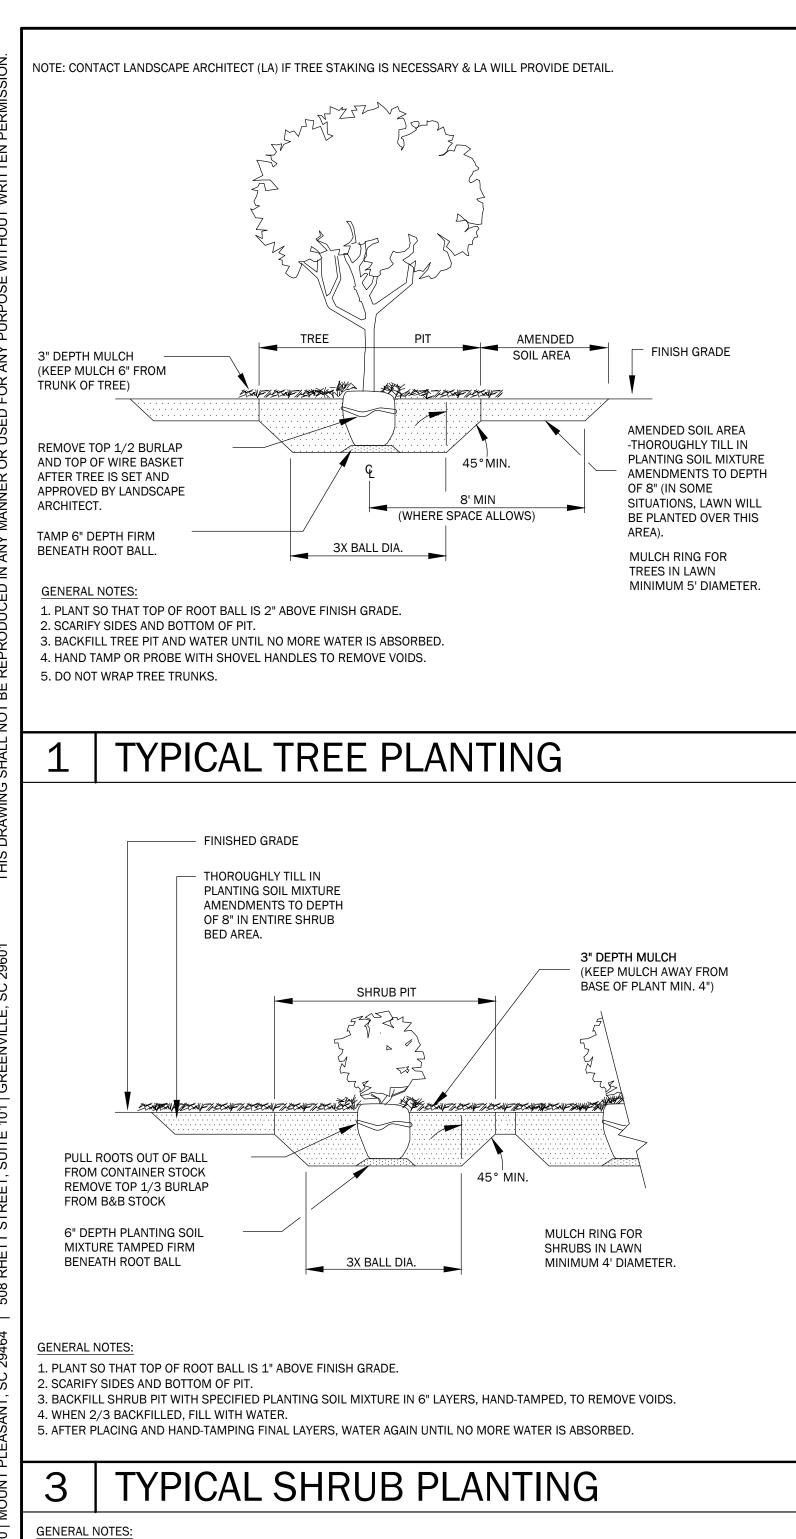



QUE HIRE

11/28/2018 DRAWN BY: CHECKED BY:

**REVISION HISTORY** 

PLANTING PLAN



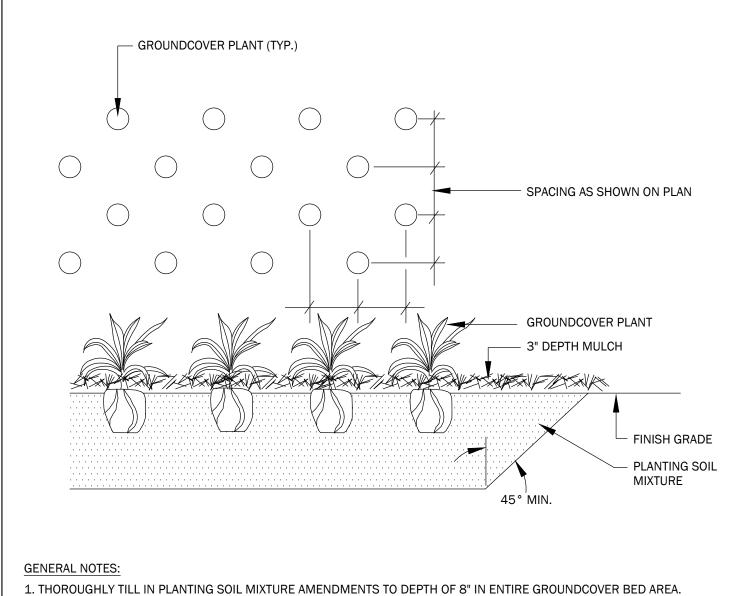

## 2 | GRASS/GROUNDCOVER PLANTING

1. THE TECHINICAL SPECIFICATIONS ARE MADE A PART OF THESE PLANS AND SHALL BE CONSULTED BY THE CONTRACTOR. THE CONTRACTOR IS RESPONSIBLE FOR IMPLEMENTING WORK AS SPECIFIED IN THE TECHNICAL SPECIFICATIONS AND ON THESE PLANS.

2. CONTRACTOR SHALL NOTIFY THIS OFFICE OF ANY DISCREPANCIES PRIOR TO BEGINNING OR CONTINUING WORK.

2. WORK SOIL TO LOOSE, UNIFORMLY FINE TEXTURE.

3. HAND-TAMP BACKFILL TO REMOVE VOIDS AND AIR POCKETS.

4. WATER IMMEDIATELY AFTER PLANTING UNTIL NO MORE WATER IS ABSORBED.

3. THERE WILL BE NO SUBSTITUTIONS, DELETIONS OR ADDITIONS WITHOUT APPROVAL OF THIS OFFICE. 4. SIZE OF PLANT MATERIALS SHALL CONFORM WITH THE CURRENT EDITION OF 'AMERICAN STANDARD FOR NURSERY STOCK' FOR NUMBER ONE GRADE NURSERY STOCK AS ADOPTED BY THE AMERICAN ASSOCIATION OF NURSERYMEN AND AMERICAN NATIONAL STANDARDS INSTITUTE.

5. THE QUANTITIES ON THE SCHEDULE ARE ONLY A GUIDE. ALL QUANTITIES SHALL BE VERIFIED BY THE CONTRACTOR ON THE PLANTING PLAN.

### PLANT SCHEDULE NOTES

ABSORPTION RATIO; DELETERIOUS MATERIAL; BUFFER PH LEVELS; AND MINERAL AND PLANT-NUTRIENT CONTENT OF THE SOIL.	JUWI
2. A MINIMUM OF THREE REPRESENTATIVE SAMPLES SHALL BE TAKEN FROM VARIED LOCATIONS FOR EACH SOIL TO BE USED OR AMENDED FOR PLANTING PURPOSES.	
3. SUBMIT TO LANDSCAPE ARCHITECT THE LAB RECOMMENDATIONS FOR SOIL TREATMENTS AND SOIL AMENDMENTS TO BE INCORPORATED. INDICATE LAB RECOMMENDATIONS IN WEIGHT PER 1000 SQ. FT. OR VOLUME PER CU. YD. FOR NITROGEN,	


INCORPORATED. INDICATE LAB RECOMMEND PHOSPHORUS, AND POTASH NUTRIENTS AND ORGANIC AND INORGANIC SOIL AMENDMENTS TO BE ADDED TO PRODUCE PLANTING SOIL SUITABLE FOR HEALTHY, VIABLE PLANTS.

1. FOR EACH UNAMENDED SOIL TYPE, FURNISH SOIL ANALYSIS AND A WRITTEN REPORT BY A QUALIFIED SOIL-TESTING LABORATORY

4. ALL SOILS USED FOR PLANTING SHALL BE PREPARED AS NECESSARY USING ORGANIC AND INORGANIC SOIL AMENDMENTS AND FERTILIZERS IN THE QUANTITIES RECOMMENDED IN THE SOIL ANALYSIS REPORT TO PRODUCE SATISFACTORY PLANTING SOIL FOR HEALTHY, VIABLE PLANTS. PLANTING SOILS SHALL HAVE A PH LEVEL BETWEEN 6.0 AND 7.0.

5. IN ALL PLANTING AREAS, SPREAD PLANTING SOIL TO A DEPTH OF 8 INCHES BUT NOT LESS THAN REQUIRED TO MEET FINISH GRADES AFTER NATURAL SETTLEMENT.

### SOIL NOTES

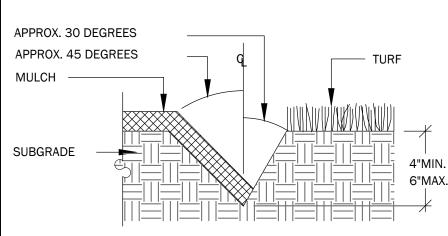

LAWN EDGE DETAIL

1. EXCAVATE TRENCH BY HAND W/ SPADE 2. ADD EXCESS SOIL TO ADJACENT PLANT BED AFTER PULLING BACK EXISTING MULCH. RAKE SOIL AND SMOOTH BEFORE MULCHING.

PLANT SCHEDULE TREES BOTANICAL NAME / COMMON NAME HEIGHT. **REMARKS** B&B OR CONT. MS, FWF, Lagerstroemia x `Natchez` / Natchez Crape Myrtle | Quercus virginiana / Southern Live Oak B&B 2.5"Cal B&B 4"Cal | Quercus virginiana / Southern Live Oak Significant Replacement FWF, SP SHRUBS BOTANICAL NAME / COMMON NAME CONT HEIGHT SPACING REMARKS Azalea indica `Mrs. G.G. Gerbing` / Mrs. G.G. Gerbing Azalea 148" o.c. CONT 7 gal | Loropetalum chinense rubrum `Ruby` / Dwarf Ruby Fringe Flower 3 gal 36" o.c. 148" o.c. CONT 7 gal | Viburnum suspensum / Sandankwa Viburnum GROUND COVERS HEIGHT REMARKS BOTANICAL NAME / COMMON NAME SOD2 2,281 sf Cynodon dactylon / Bermuda Grass sod Trachelospermum asiaticum `Asiatic` / Asiatic Jasmine 4"pot

MS MULTI-STEMMED TRUNK

CAL TRUNK CALIPER

GAL GALLON CONTAINER

EGG EGG CAN CONTAINER

B&B BALLED AND BURLAPPED

### SIGNIFICANT TREE MITIGATION:

TWO SIGNIFICANT TREES TO BE REMOVED: PENALTY OF \$500 TO BE PAID TO THE CITY'S 'TREE TRUST FUND' TWO 4" CAL. TREES PLANTED AS REPLACEMENTS (SEE SCHEDULE)

FWF FULL WELL FORMED

TF TREE FORM HABIT

SPECIMEN MATERIAL

### REGULATED TREE MITIGATION:

151.080 USE OF LAND OR BUILDINGS: "IN ALL BUILDABLE AREAS, A MINIMUM OF 12 TREES PER ACRE SHALL BE SAVED AND/OR REPLACED ANYWHERE WITHIN THE PROPERTY CALCULATED AT TOTAL DBH IN ORDER TO PROVIDE FLEXIBILITY, WITH A MINIMUM OF TWO AND ONE HALF INCH CALIPERS OR EQUIVALENT SIZE TREES."

**BUILDABLE AREA: 1.55 ACRES** MINIMUM TREES REQUIRED WITHIN THE PROPERTY: 12 (TREES) X 1.55 (ACRES)= 19 TREES TREES TO REMAIN ON SITE: 257 TREES (CITY OF GOOSE CREEK 85 TREES (BERKELEY COUNTY)

PLANT SCHEDULE AND MITIGATION


CON CONTAINERIZED MATERIAL

ESP ESPALIER

BARE ROOT MATERIAL

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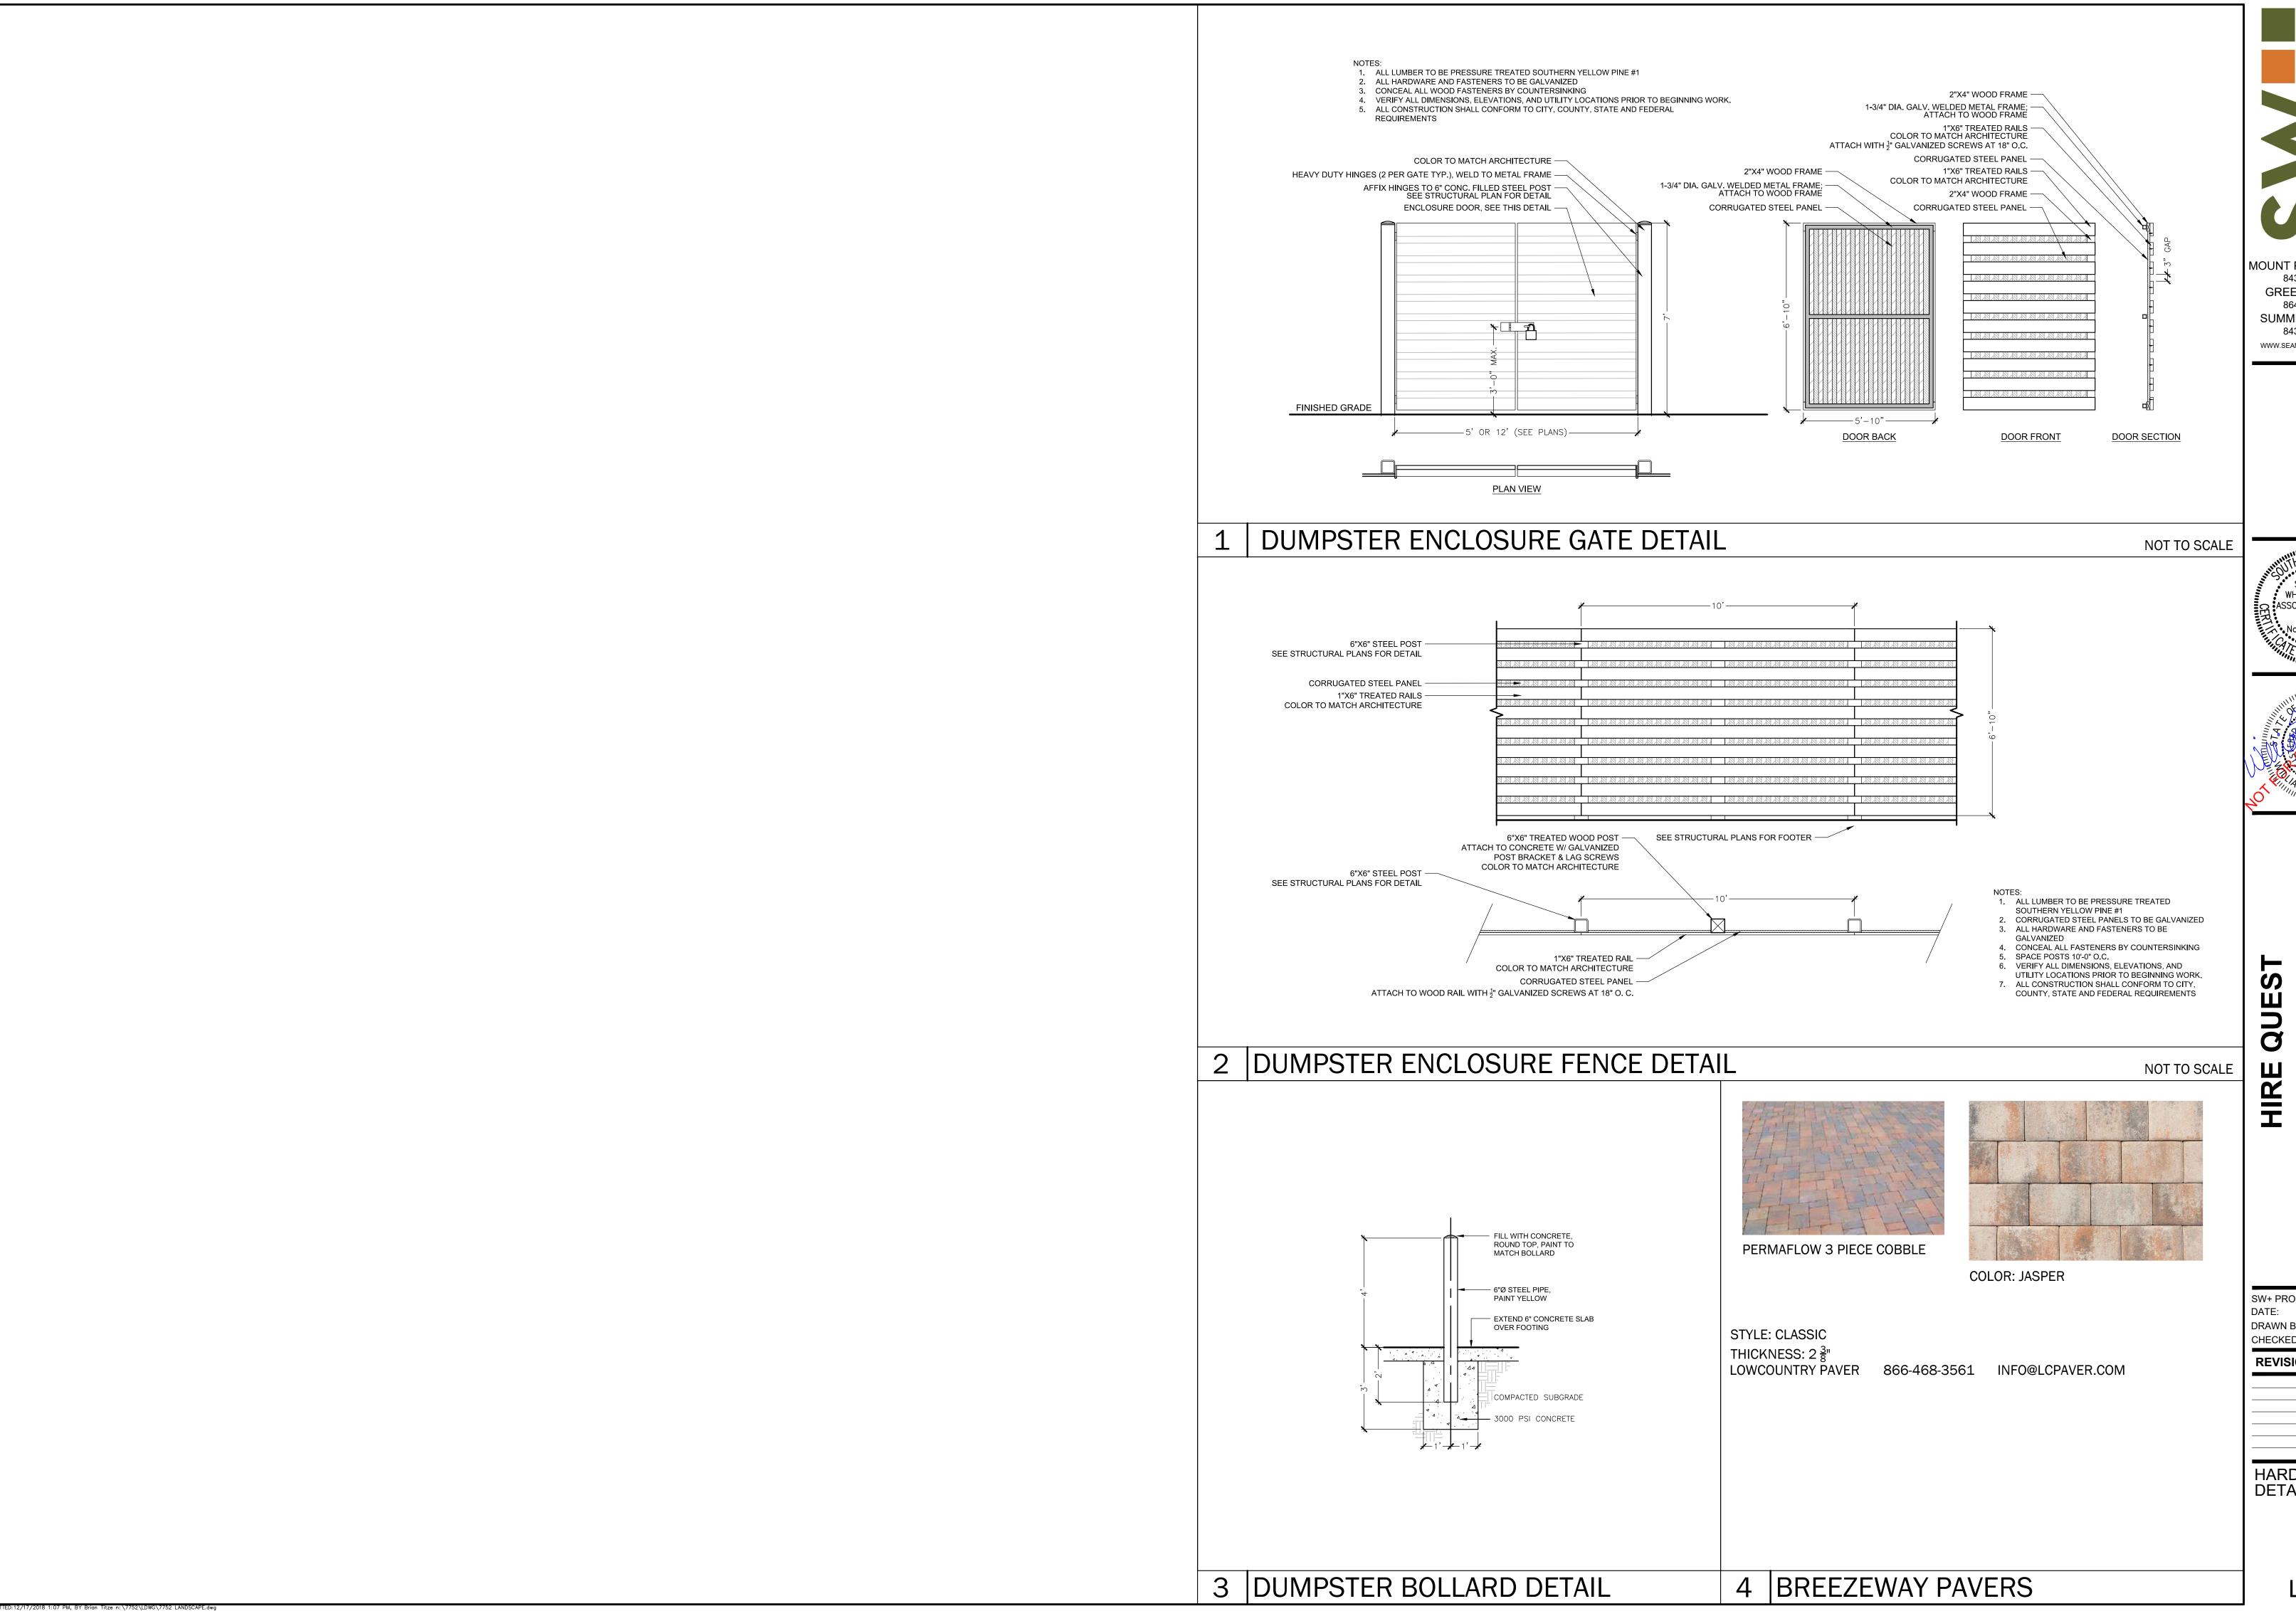


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11/28/2018 DRAWN BY:

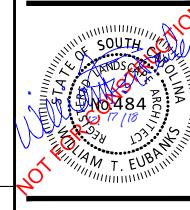**REVISION HISTORY** 

PLANT SCHEDULE & DETAILS






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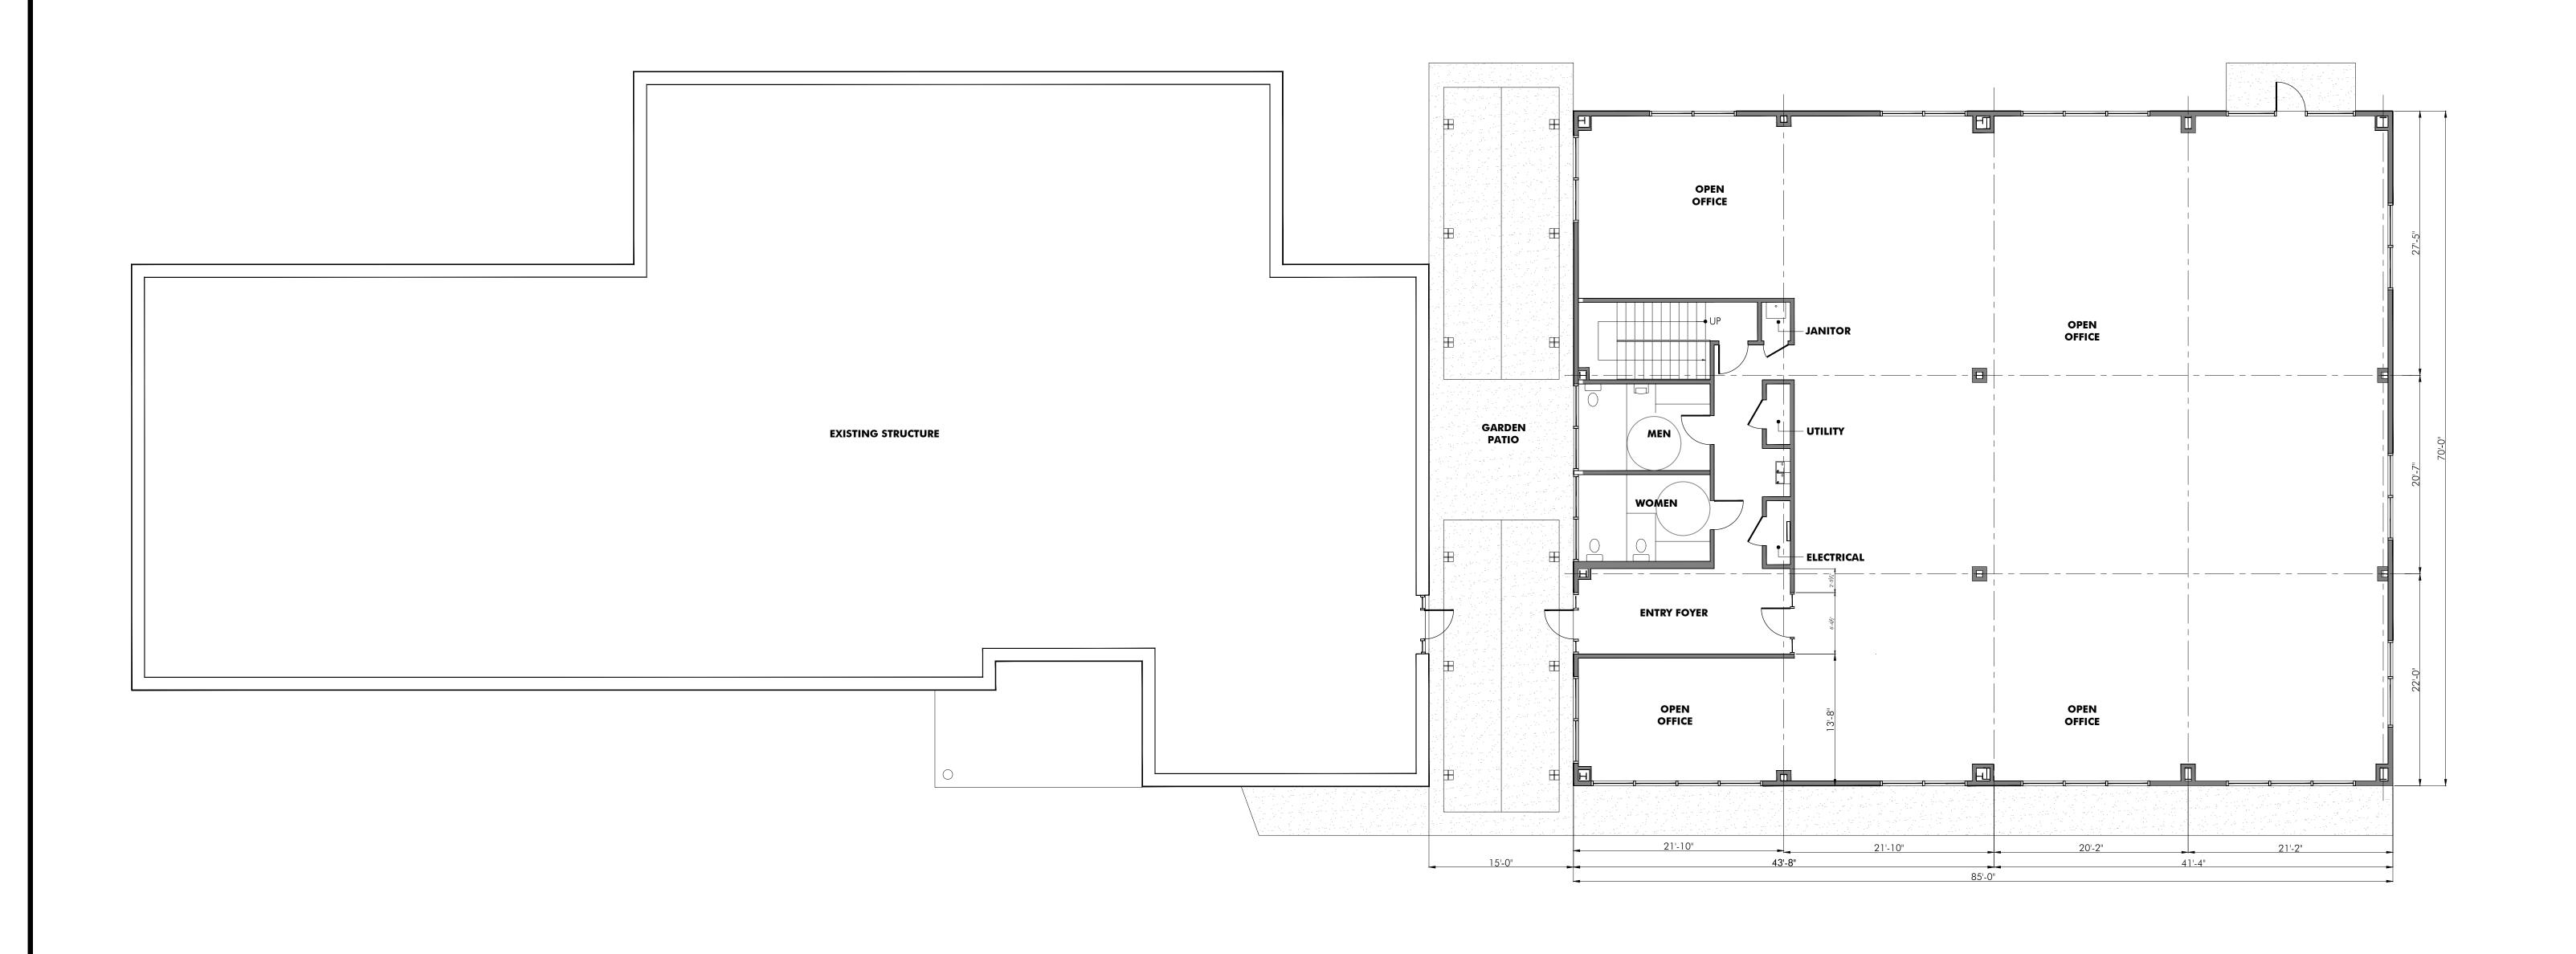




11/28/2018 DRAWN BY: CHECKED BY:

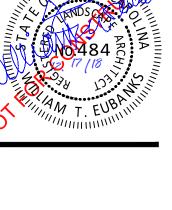**REVISION HISTORY** 

HARDSCAPE DETAILS



SD 1.0 1/8" = 1'-0"

These plans are copyrighted and are subject to protection as an "Architectural Work" under section 102 of the Copyright Act 17 U.S.O. as amended December 1990 and known as the Architectural Works Protection Act of 1990. The protection includes, but is not limited the Architectural Works Protection Act of 1990. The protection includes, but is not limited to; the overall form, arrangement and composition of spaces and elements of the design. Under such protection, unauthorized use of these plans, work, or building represented, can result in cessation of construction, buildings being seized and/or monetary compensation to Oceana Design & Construction, LLC

GENERAL NOTE

DO NOT SCALE FROM THIS DRAWING

All Dimensions. Limit Lines, & Setbacks to be checked on site by the General Contractor prior to commencing work, preparation of shop drawings, or ordering materials.

NOT FOR CONSTRUCTION USE FOR HOA/ARB REVIEW PURPOSES ONLY 1.17.19


ISSUED

Date Purpose
1.17.19 POA/ARB REVIEW REVISED Date Purpose

CONTENTS


PROJECT
Schematic Design

NEW OFFICE BUILDING
HIRE QUEST
1.0

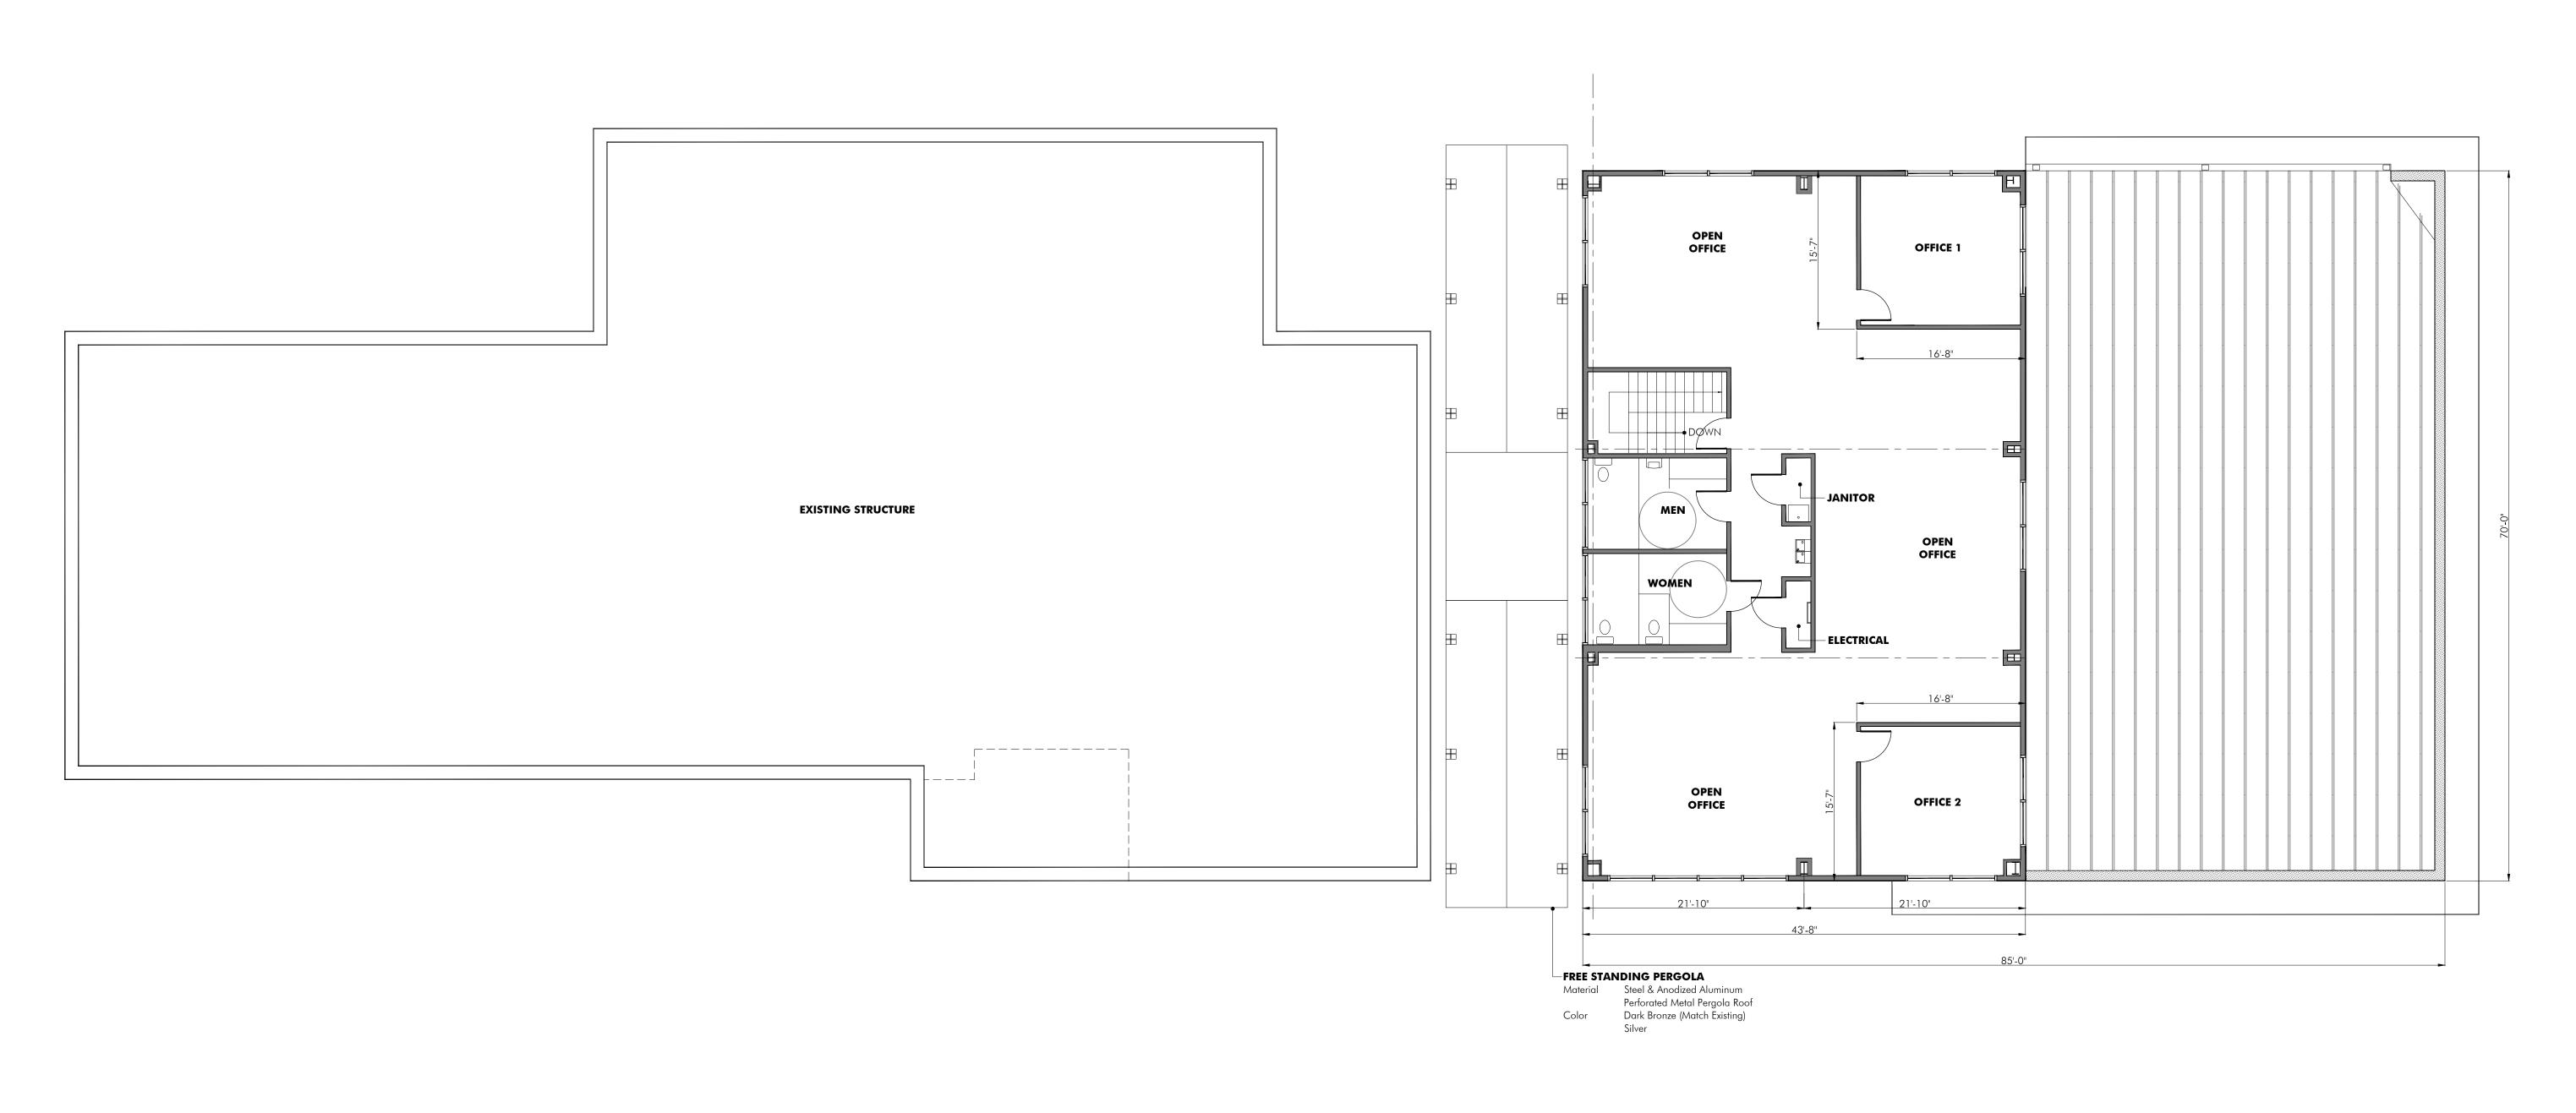

SECOND FLOOR PLAN

SD 1.0 %" = 1'-0"

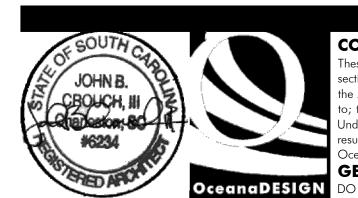

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GENERAL NOTE

OceanaDESIGN

John B Crouch III AIA 28 West End Avenue Isle of Palms, SC 29451

Vx 843.270.2976 John@OceanaDesignLLC.com Fx 843.886.0797

Fx 843.886.0797


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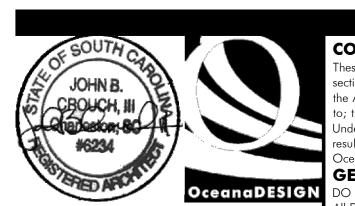
ISSUED REVISED Date Purpose
1.17.19 POA/ARB REVIEW Date Purpose

CONTENTS

PROJECT
Schematic Design

NEW OFFICE BUILDING HIRE QUEST 1.



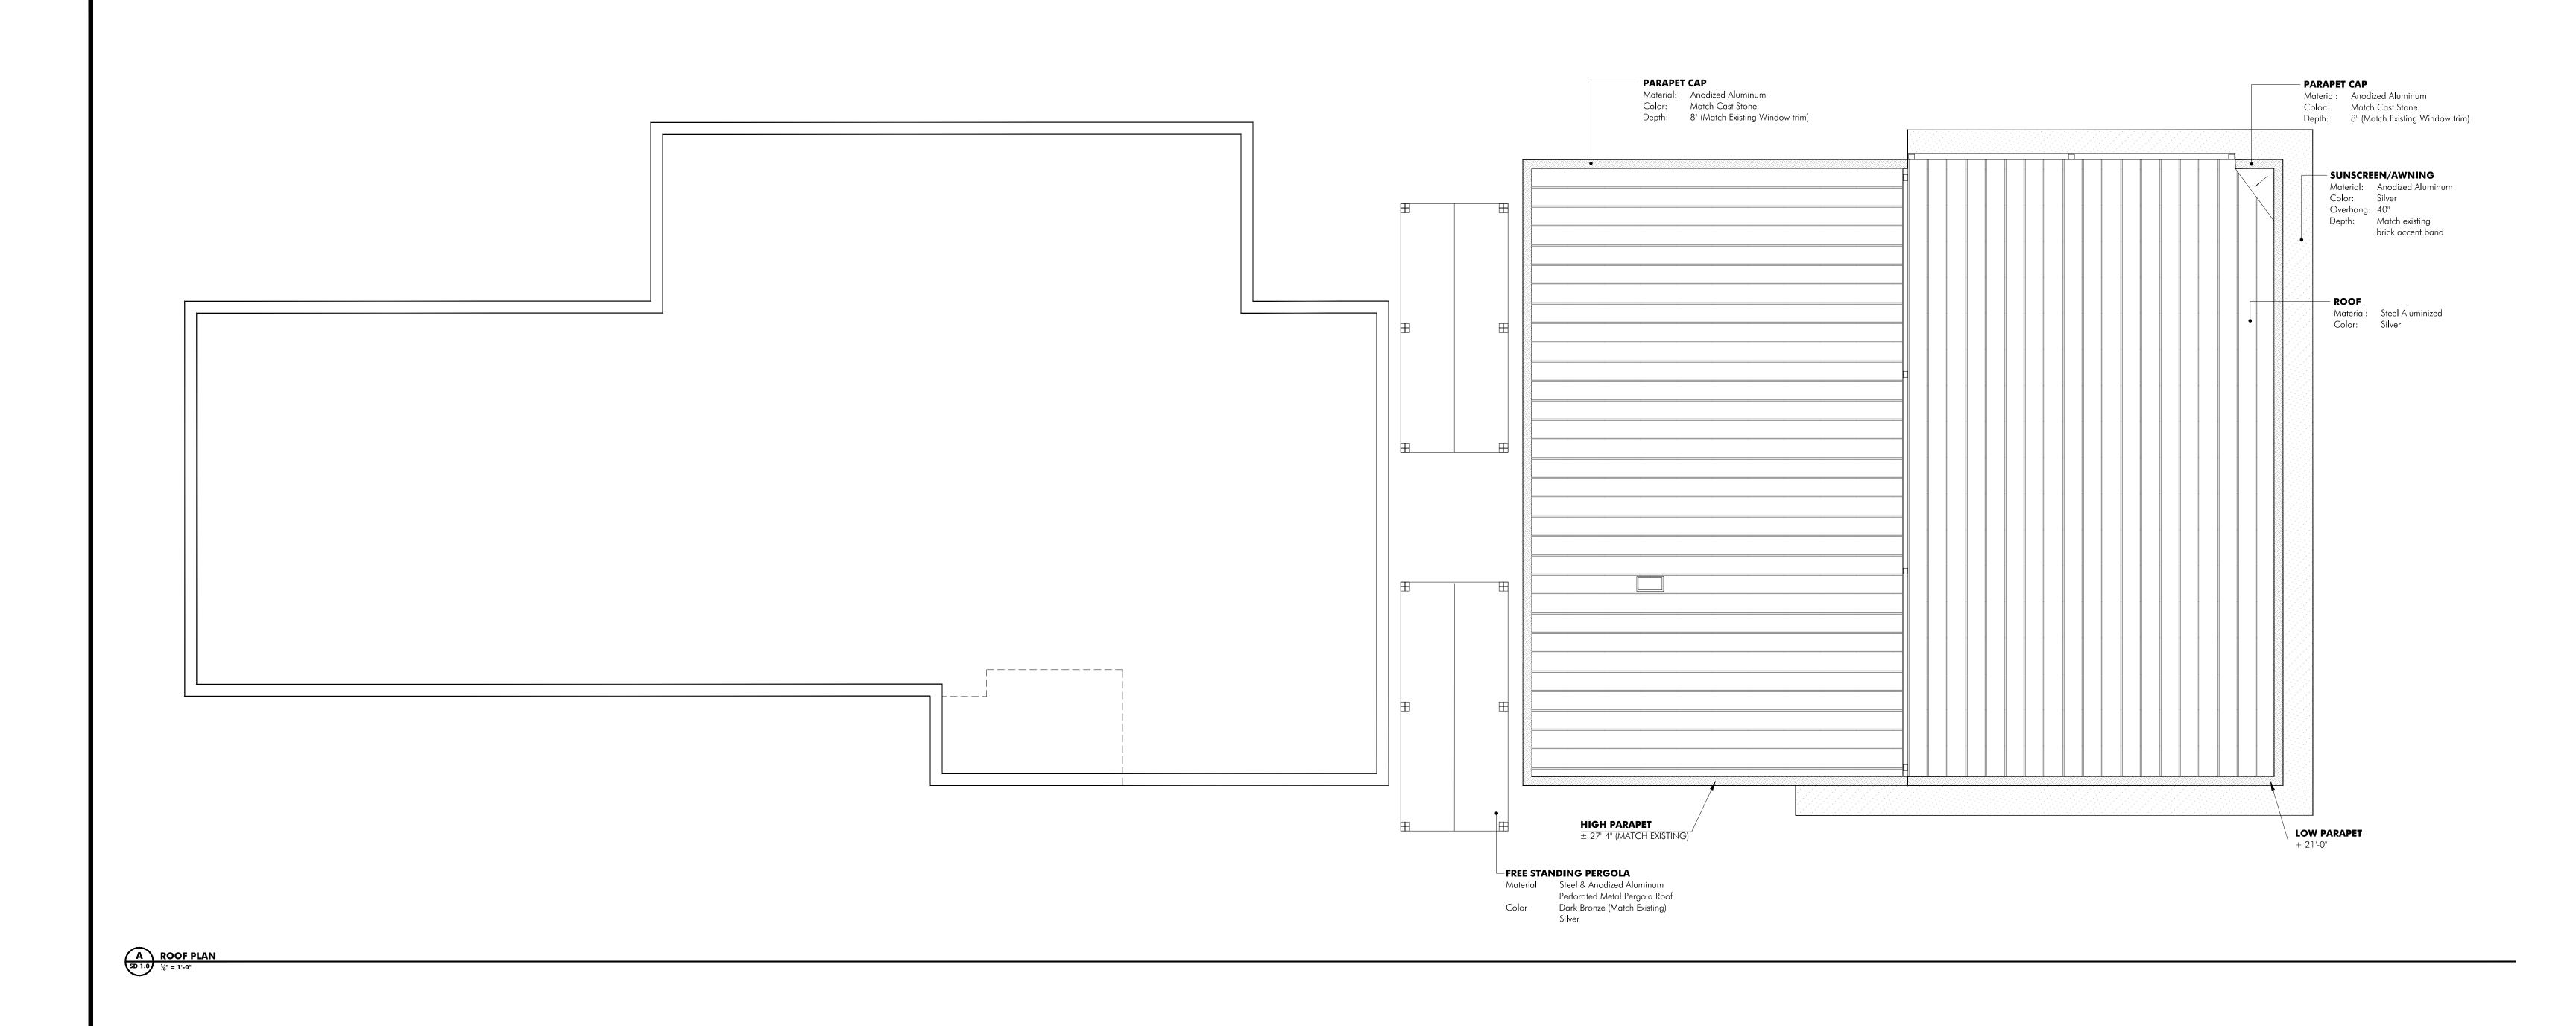

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GENERAL NOTE OceanaDESIGN DO NOT SCALE FROM THIS DRAWING John B Crouch III AIA 28 West End Avenue Isle of Palms, SC 29451
Vx 843.270.2976 John@OceanaDesignLLC.com Fx 843.886.0797
Fx 843.886.0797 NOT FOR CONSTRUCTION USE
FOR HOA/ARB REVIEW PURPOSES ONLY
1.17.19

ISSUED REVISED Date Purpose
1.17.19 POA/ARB REVIEW Date Purpose


CONTENTS

PROJECT
Schematic Design

NEW OFFICE BUILDING
HIRE QUEST
1.2

111SPRINGHALL DRIVE GOOSE CREEK, SC 29445



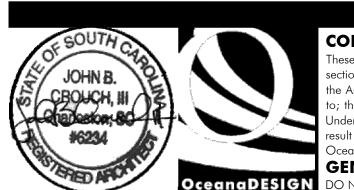

nese plans are copyrighted and are subject to protection as an "Architectural Work" under

section 102 of the Copyright Act 17 U.S.O. as amended December 1990 and known as the Architectural Works Protection Act of 1990. The protection includes, but is not limited o; the overall form, arrangement and composition of spaces and elements of the design. Inder such protection, unauthorized use of these plans, work, or building represented, can result in cessation of construction, buildings being seized and/or monetary compensation to Oceana Design & Construction, LLC **GENERAL NOTE** 

OceanaDESIGN DO NOT SCALE FROM THIS DRAWING John B Crouch III AIA 28 West End Avenue Isle of Palms, SC 29451
Vx 843.270.2976 John@OceanaDesignLLC.com Fx 843.886.0797 prior to commencing work, preparation of shop drawings, or ordering materials. NOT FOR CONSTRUCTION USE FOR HOA/ARB REVIEW PURPOSES ONLY 1.17.19

Date Purpose
1.17.19 POA/ARB REVIEW


Date Purpose

**CONTENTS**ELEVATIONS

Schematic Design

**NEW OFFICE BUILDING** HIRE QUEST 2.0

111SPRINGHALL DRIVE GOOSE CREEK, SC 29445

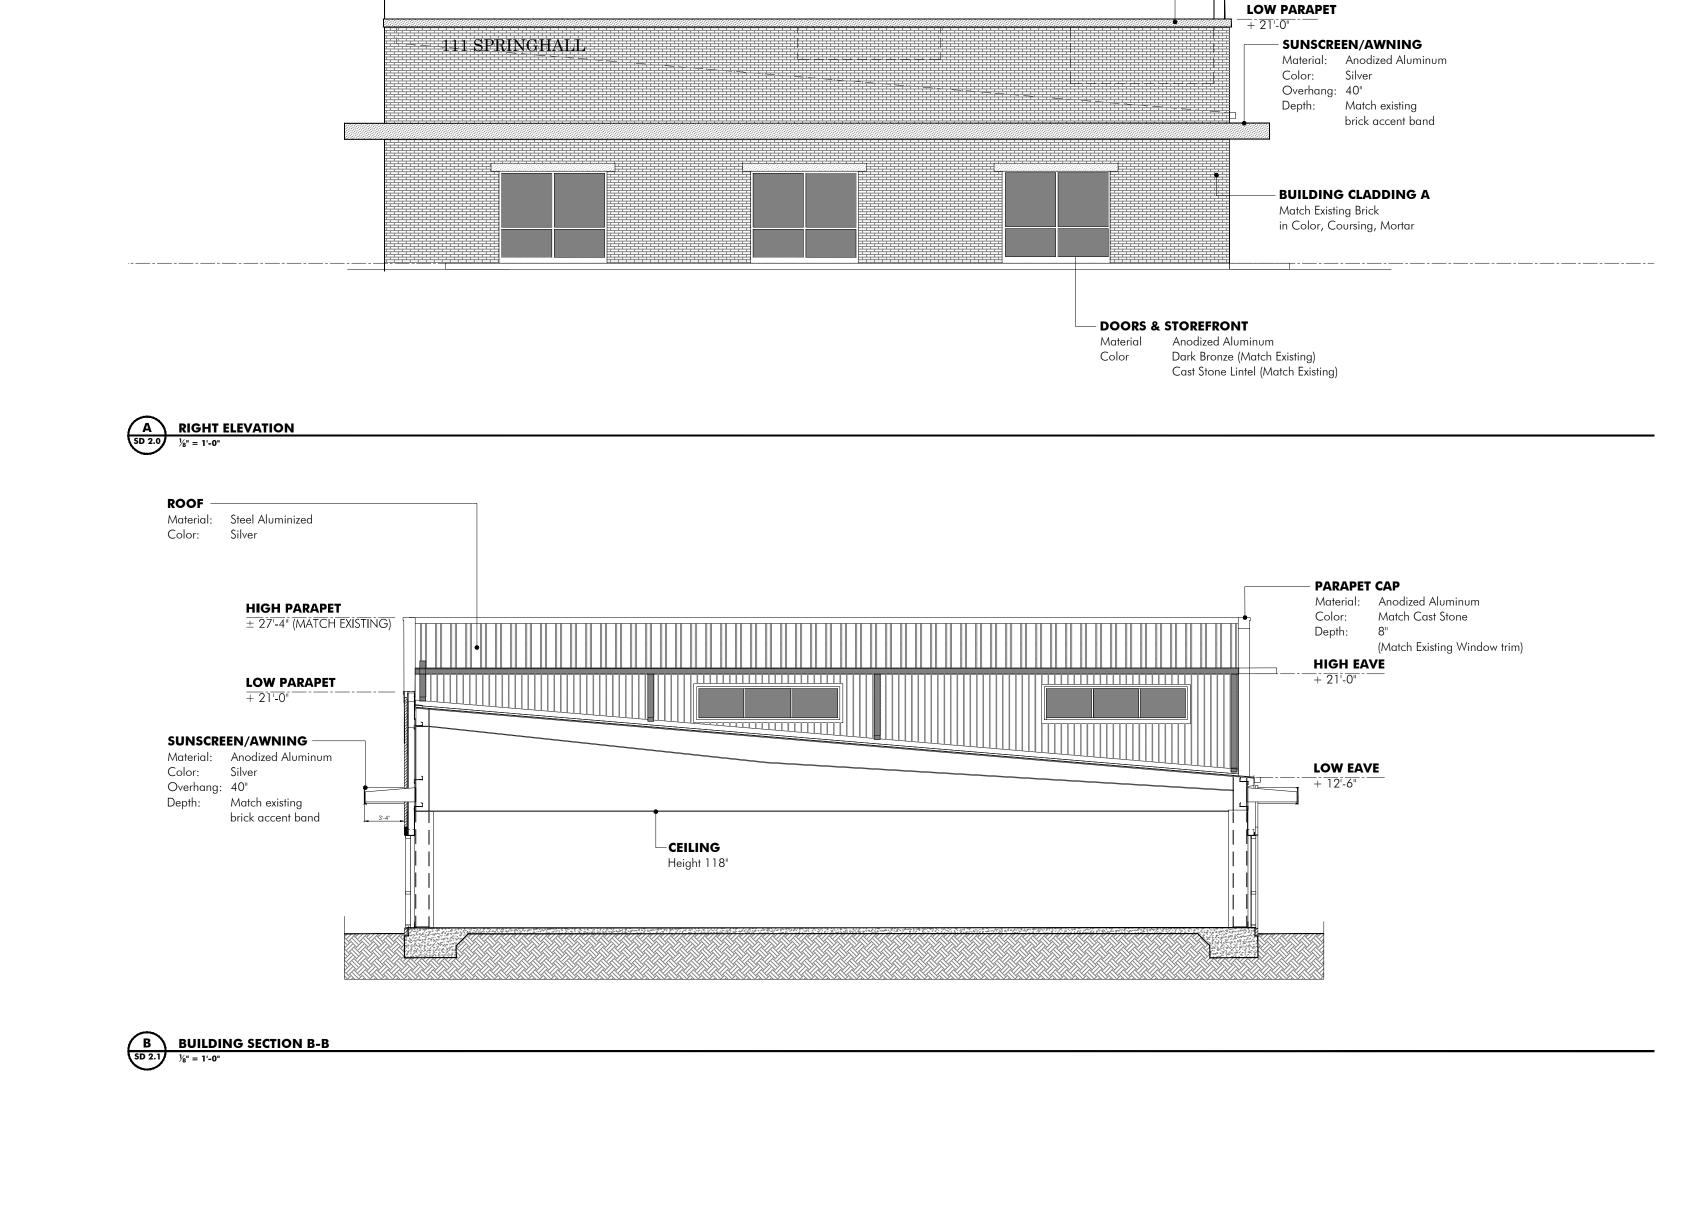



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ISSUED Date Purpose
1.17.19 POA/ARB REVIEW

HIGH PARAPET

± 27'-4" (MATCH EXISTING)

REVISED Date Purpose **CONTENTS**ELEVATIONS

PROJECT Schematic Design

PARAPET CAP

Depth:

Material: Anodized Aluminum

Color: Match Cast Stone

(Match Existing Window trim)

NEW OFFICE BUILDING HIRE QUEST

GOOSE CREEK, SC 29445

111SPRINGHALL DRIVE

SD



1.17.19 Subject: Existing Photo

Existing Photos
111 SPRINGHALL, GOOSE CREEK

New Office Building



**AERIAL** 



**ENTRY FROM SPRINGHALL** 



SITE FROM GREENLAND



FRONT LEFT 3/4 VIEW (Entry at far Right)



**ENTRY** 

### **Aluminum Parapet Cap**

Pac-Clad
Sandstone
Matches Existing Lintels & Parapet Caps



PROPOSED COLORS & MATERIALS

Matches Existing

John B. Crouch III A R C H I T E C T NEW OFFICE BUILDING: 111 SPRINGHALL LANE GOOSE CREEK, SC 29941

666 HARBOR CREEK PLACE CHARLESTON, SC 29412

# 115,117,119 S. GOOSE CREEK BLVD. PARKING PLANS

GOOSE CREEK, BERKELEY COUNTY, SC

### SPECIAL R/W NOTES FOR SCDOT PROJECTS:

1) CONTRACTOR TO REFER TO THE MOST CURRENT EDITION OF THE SCDOT STANDARD DRAWINGS TO MAKE SURE THAT THE DETAILS SHOWN HEREON ARE THE MOST CURRENT SCDOT DETAILS. SEE SHEET C508 FOR SCDOT STANDARD DETAILS.

2) ANY FIELD CHANGES WITHIN SCDOT R/W OR CHANGES THAT WOULD IMPACT SCDOT R/W WILL REQUIRE WRITTEN SCDOT APPROVAL PRIOR TO CHANGES BEING IMPLEMENTED IN THE FIELD." (E.G. DRAINAGE, GRADING, ACCESS DESIGN ETC.).

3) SCDOT WILL REQUIRE THAT YOU PROVIDE A TRAFFIC CONTROL PLAN (PHASED AS

PERMITS FOR NEW CONNECTIONS OR RELOCATION OF EXISTING SERVICES. NO UTILITY WORK CAN BEGIN WITHIN THE R/W WITHOUT AN APPROVED SCDOT ENCROACHMENT PERMIT FOR EACH UTILITY. SCDOT WILL NOT ALLOW AN OPEN CUT OF A STATE ROAD IF IT WAS RECENTLY RESURFACED.

5) ALL PIPE INSTALLATIONS WITHIN SCDOT RIGHT OF WAY TO MEET CURRENT SCDOT BACKFILL AND COMPACTIVE STANDARDS (SEE SCDOT STANDARD DRAWINGS SECTION

6) THE DETAILS SHOWN ON THIS PLAN ARE FOR REFERENCE ONLY. FULL SIZE DETAILS ARE AVAILABLE ON THE SCDOT WEBPAGE AT http://www.scdot.org/doing/sd\_Book.aspx

7) THE OWNER SHALL BE RESPONSIBLE FOR THE MAINTENANCE OF DRIVEWAYS AND OTHER ACCESS POINTS, INCLUDING ANY DRAINAGE STRUCTURES, FOR AREAS WITHIN THE RIGHTS-OF-WAYS OF STATE MAINTAINED FACILITIES IN PERPETUITY. DRIVEWAY ACCESS SHALL BE MAINTAINED FOR INGRESS/EGREES - BLOCKING OF ACCESS WILL


### CONSTRUCTION SEQUENCE

ITEMS MUST OCCUR IN THE ORDER LISTED; ITEMS CANNOT OCCUR CONCURRENTLY UNLESS SPECIFICALLY NOTED.

- 1. RECEIVE NPDES COVERAGE FROM DHEC 2. PRE-CONSTRUCTION MEETING (ON-SITE IF MORE THAN 10 DISTURBED AND NON-LINEAR)
- 3. NOTIFY DHEC EQC REGIONAL OFFICE OR OCRM OFFICE 48 HOURS PRIOR TO BEGINNING LAND- DISTURBING
- 4. INSTALLATION OF CONSTRUCTION ENTRANCE(S)

THE STRUCTURES ARE COMPLETELY INSTALLED)

- 5. CLEARING & GRUBBING ONLY AS NECESSARY FOR INSTALLATION OF PERIMETER CONTROLS
- 6. INSTALLATION OF PERIMETER CONTROLS (E.G., SILT FENCE)
- 7. CLEARING & GRUBBING ONLY IN AREAS OF BASINS/ TRAPS/ PONDS 8. INSTALLATION OF BASINS/ TRAPS/ PONDS AND INSTALLATION OF DIVERSIONS TO THOSE STRUCTURES (OUTLET STRUCTURES MUST BE COMPLETELY INSTALLED AS SHOWN ON THE DETAILS BEFORE PROCEEDING TO NEXT STEP: AREAS DRAINING TO THESE STRUCTURES CANNOT BE DISTURBED UNTIL THE STRUCTURES AND DIVERSIONS TO
- 9. CLEARING & GRUBBING OF SITE OR DEMOLITION (SEDIMENT & EROSION CONTROL MEASURES FOR THESE AREAS MUST ALREADY BE INSTALLED)
- 10. ROUGH GRADING
- 11. INSTALLATION OF STORM DRAIN SYSTEM AND PLACEMENT OF INLET PROTECTION AS EACH INLET IS INSTALLED 12. FINE GRADING, PAVING, ETC.
- 13. PERMANENT/ FINAL STABILIZATION 14. REMOVAL OF TEMPORARY SEDIMENT & EROSION CONTROL MEASURES AFTER ENTIRE AREA DRAINING TO THE
- STRUCTURE IS FINALLY STABILIZED (THE DEPARTMENT RECOMMENDS THAT THE PROJECT OWNER/ OPERATOR HAVE THE SWPPP PREPARER OR REGISTRATION EQUIVALENT APPROVE THE REMOVAL OF TEMPORARY
- 15. PERFORM AS-BUILT SURVEYS OF ALL DETENTION STRUCTURES AND SUBMIT TO DHEC OR MS4 FOR
- ACCEPTANCE.
- 16. SUBMIT NOTICE OF TERMINATION (NOT) TO DHEC AS APPROPRIATE.

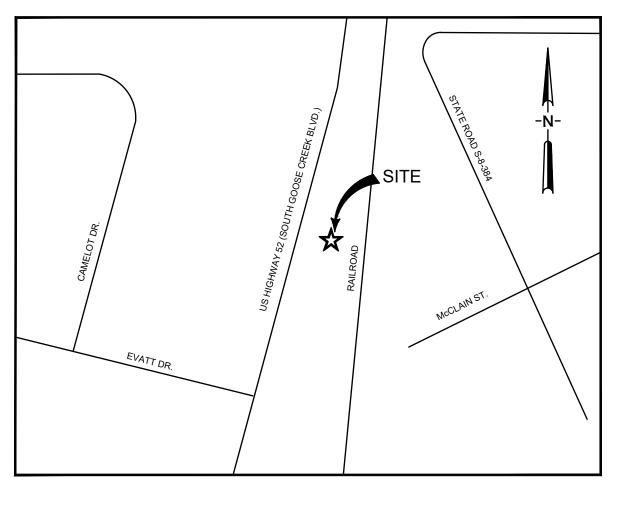

**VICINITY MAP** 

### **SHEET INDEX:**

C0 - COVER SHEET **C001 - BOUNDARY SURVEY** 

C1 - EXISTING CONDITIONS SURVEY

C2 - EROSION CONTROL AND DEMOLITION

C3 - NEW SITE PLAN

C4 - GRADING AND DRAINAGE PLAN

L100 - LANDSCAPE PLANTING PLAN

**C5 - CONSTRUCTION DETAILS** 

**C6 - CONSTRUCTION DETAILS** 

**C7 - CONSTRUCTION DETAILS** 

### CONTACT INFORMATION

OWNER / DEVELOPER SPRINGBOARD INVESTMENTS LLC. 115 S. GOOSE CREEK BLVD. GOOSE CREEK, SOUTH CAROLINA 29402

**CONTACT: THERESA WEISE** TEL: 843-442-7400


CIVIL ENGINEER: FORSBERG ENGINEERING & SURVEYING, INC. ATTN: GADSDEN A. LINTON III P.O. BOX 30575 CHARLESTON, SOUTH CAROLINA 29407

- THE TMS NUMBERS ARE 243-12-07-029/-030/-031 (BERKELEY COUNTY)
- TOTAL TRACT AREA IS 0,487 ACRES. THE PROPERTY IS ZONED GC (GENERAL COMMERCIAL).

### CONSTRUCTION/DEMOLITION DELIVERY ROUTE


CONSTRUCTION TRAFFIC SHALL ACCESS THE SITE BY S. GOOSE CREEK BLVD. EXIT INTERSTATE I-26 TO HWY 78 EASTBOUND, FOLLOW HWY 78 TO RIVERS AVE (HWY 52) NORTHBOUND. FOLLOW HWY 52 NORTH AND THE SITE WILL BE ON THE RIGHT SIDE OF RIVERS AVE. VEHICLES WILL BE ENTERING AND EXITING FROM THE CONSTRUCTION ENTRANCE LOCATED ON RIVERS AVE.(S. GOOSE CREEK BLVD).


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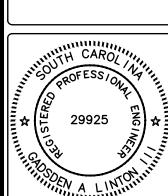


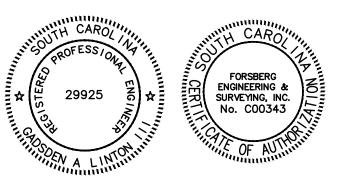Know what's below. Call before you dig.

HE SOUTH CAROLINA STATE LAW REQUIRES HAT EXCAVATORS GIVE A 72-HOUR NOTICE WORKING DAYS EXCLUDING WEEKENDS AND HOLIDAYS), FOR THE LOCATORS TO GET OU' TO MARK THE AREA. AFTER A TICKET HAS BEEN PROCESSED, YOU WILL KNOW WHEN YOU ARE LEGALLY FREE TO PROCEED WITH THE DIGGING WORK AND WHICH UTILITIES IN THE AREA P.U.P.S. WILL BE NOTIFYING FOR YOU ANY UTILITIES THAT P.U.P.S. DOES NOT NOTIFY, YOU WILL BE RESPONSIBLE FOR ASK THAT YOU LEAVE A 2 1/2 FEET MARGIN ASK HAI YOU LEAVE A 2 1/2 FEET MARGIN ON EACH SIDE OF A MARKED UTILITY LINE. ALSO NOTE THAT YOUR REQUEST IS GOOD FOR 15 WORKING DAYS AFTER IT HAS BEEN PROCESSED BY OUR SYSTEM.



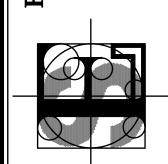

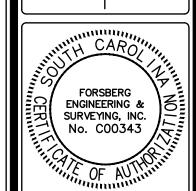

**GADSDEN A. LINTON II NOVEMBER 8, 2018** 

DRAWN/CHECKED CLH/GAL

LAST REVISED **JANAURY 22, 2019** 

APPROVED


SCALE

1"=20' PROJECT NO.

> 5327 **SHEET NUMBER**

GADSDEN A. LINTON, P.E No. 29925


CURVE RADIUS DEL TA LENGTH TANGENT CH BEARING CHORD C1 11458.99' 010'22" 34.55' 17.27' S 86'11'49" E 34.55'

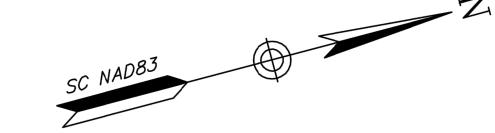

U.S. HIGHWAY 52

SOUTH GOOSE CREEK BOULEVARD

(150' R/W)

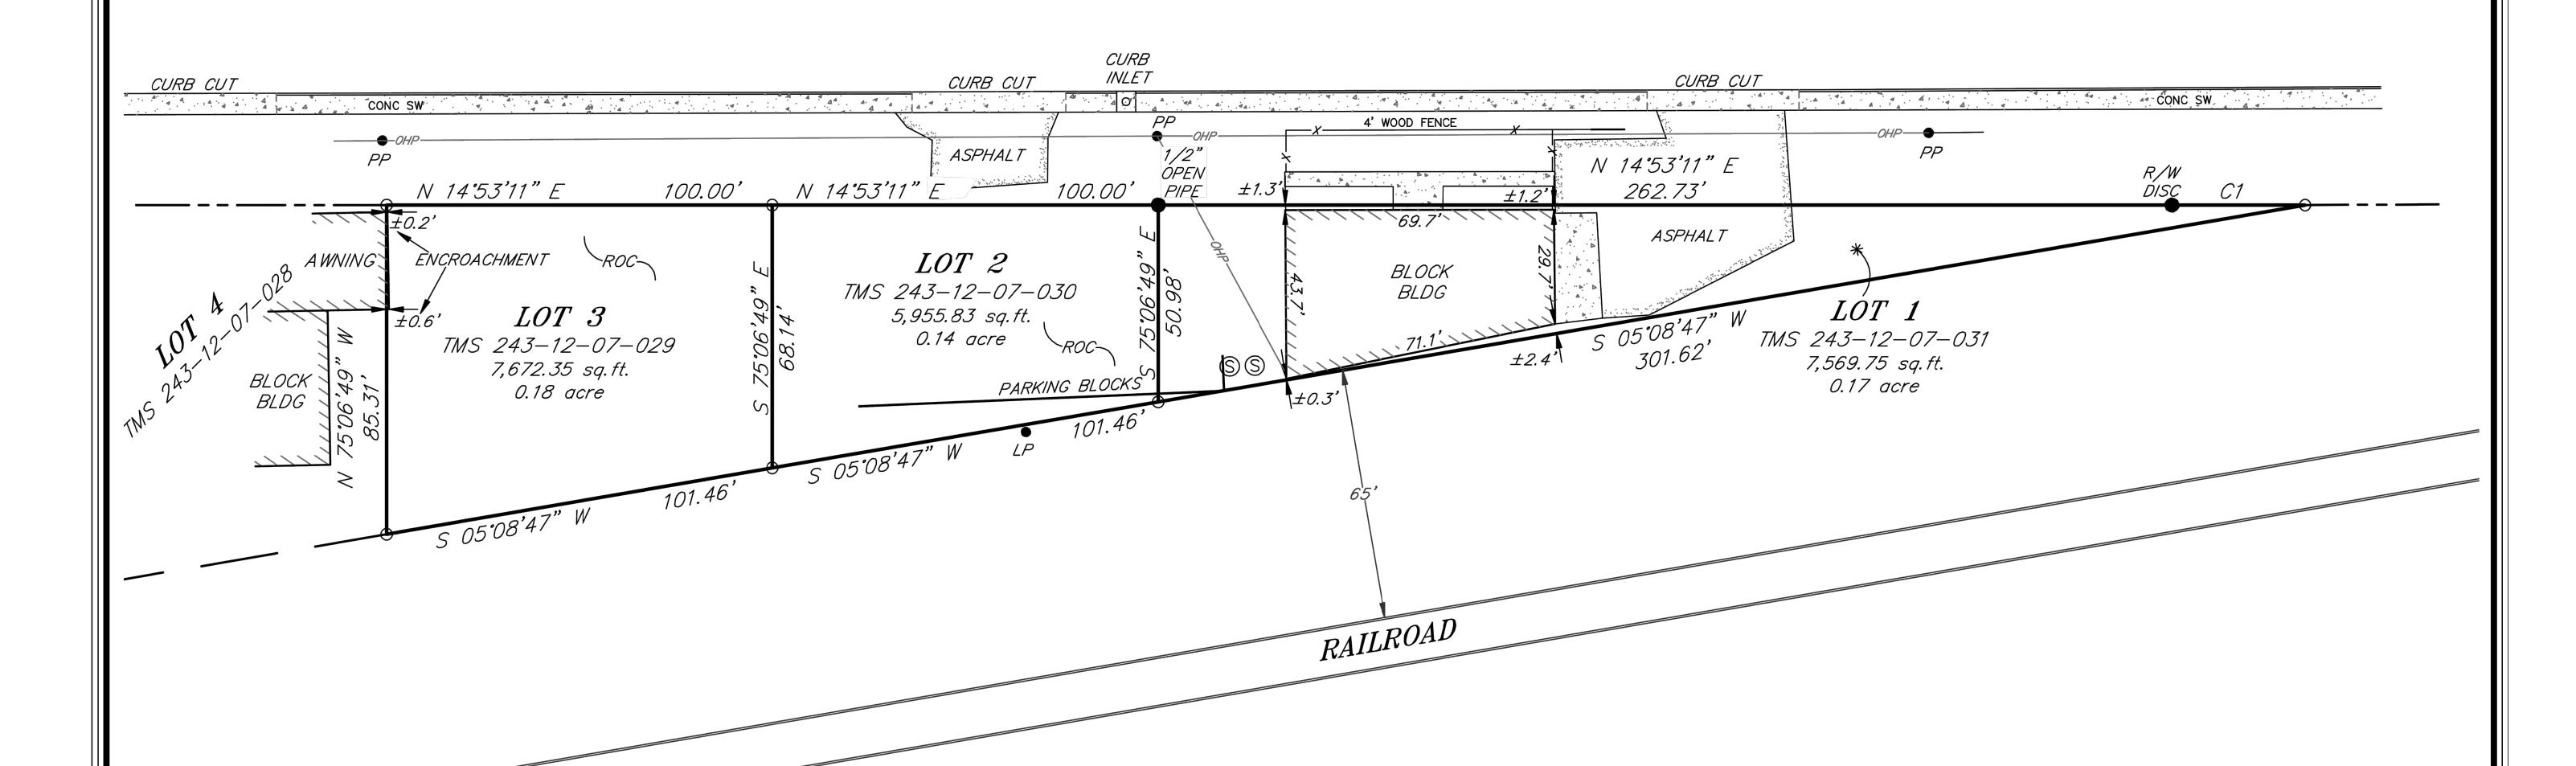

CLOSING SURVEY

SHOWING 113, 117, & 119 S GOOSE CREEK BOULEVARD

LOCATED IN THE CITY OF GOOSE CREEK, BERKELEY COUNTY, S.C.

DATE: FEBRUARY 6, 2018

**SCALE:** 1" = 40' ON SHEET SIZE 22"X34" SCALE IS 1"=20'

REFERENCE: PLAT BOOK O, PAGE 89
FLOOD ZONE: X F.I.R.M. COMMUNITY PANEL 45015C 0685 D, EFFECTIVE OCTOBER 16, 2003

I HEREBY STATE TO THE BEST OF MY KNOWLEDGE, INFORMATION AND BELIEF, THE SURVEY SHOWN HEREON WAS MADE IN ACCORDANCE WITH THE REQUIREMENTS OF THE MINIMUM STANDARDS MANUAL FOR THE PRACTICE OF LAND SURVEYING IN SOUTH CAROLINA, AND MEETS OR EXCEEDS THE REQUIREMENTS FOR A CLASS A SURVEY AS SPECIFIED THEREIN. ALSO, THERE ARE NO VISIBLE ENCROACHMENTS OR PROJECTIONS AFFECTING THE PROPERTY OTHER THAN THOSE SHOWN.

CHRISTOPHER R. EL

SCPLS No. 30759

TIM ELMER RLS, LLC. 407 COTTON HOPE LANE

TEL: (843) 482-0795 FAX: (843) 482-0796 SUMMER VILLE, SC 29483 CEImer. TERLS@gmail.com

1) THE PROPERTY IS OWNED BY SPRINGBOARD INVESTMENTS LLC

2) THE TOTAL AREA OF THE PROPERTY IS 0.487 ACRES

3) ACCORDING TO THE FLOOD INSURANCE MAP 45015C0685D DATED 10/16/2003, THIS PROPERTY LIES IN A FLOOD ZONE X

4) THIS PLAT IS NOT INTENDED TO SHOW THE EXISTENCE OR NON-EXISTENCE OF ARMY CORPS OF ENGINEERS JÚRISDICTIONAL WETLANDS.

5) THE VERTICAL DATUM USED FOR THIS SURVEY IS REFERENCED TO NGVD29

CURVE	RADIUS	DELTA	LENGTH	TANGENT	CH BEARING	CHORD
C1	11458.99	0°10'22"	34.55	17.27	S 86°11'49" E	34.55

LEGEND PP POWER POLE OHP OVERHEAD POWER ROC GRAVEL CONC CONCRETE SW SIDEWALK RIGHT OF WAY

BUILDING ASPHALT


CENTERLINE RD ADJACENT PROP


SOUTH GOOSE CREEK BOULEVARD U.S. HIGHWAY 52


(150' R/W)

INLET CURB CUT CURB CUT CONC SW. 4 4 4 4 4 4 \_\_\_\_\_\_\_4' WOOD FENCE - ASPHALI\_\_ R/W DISC N 14°53′11" E 100.00' N 14°53′11" E *100.00*′ 42.6 *262.73*′ 177, ASPHAL T AWNING *ÈNÇROACHMENT* LOT 2 BLDG TMS 243-12-07-030 5,955.83 sq.ft. 0.14 acre **LOT 1**TMS 243-12-07-031
7,569.75 sq.ft.
0.17 acre × 42.3 LOT 3 TMS 243-12-07-029 7,672.35 sq.ft. s 05°08'47" W 301.62' BLOCK BLDG × 42.1 × 42.1 ×42.3 **0.31** 5\_05°08'47" W \_\_\_ -EXISTING DITCH / 101.46, ×41.9 × 42.3 × 42.8 × 42.2 RAILROAD

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FORSBERG ENGINEERING & SURVEYING, INC. No. C00343

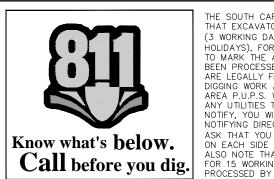

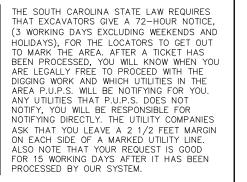DATE

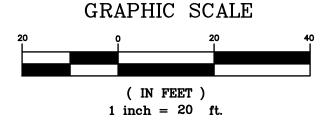**NOVEMBER 8, 2018** DRAWN/CHECKED

CLH/GAL LAST REVISED

**JANUARY 22, 2019** APPROVED

GAL

SCALE 1" = 20' PROJECT NO.

5327

SHEET NUMBER

IF SHEET IS LESS THAN (22" X 34") IT IS A REDUCED PRINT, SCALE REDUCED ACCORDINGLY

1) ALL UNDERGROUND UTILITIES TO BE PROTECTED DURING CONSTRUCTION.

2) CONTRACTOR IS RESPONSIBLE FOR EROSION CONTROL MEASURES. SEE EROSION CONTROL NOTES AND

3) THE CONSTRUCTION ACTIVITY SHALL BE IMPLEMENTED AND COMPLY WITH SECTION 2.2.2 AND BMP'S INCLUDED IN APPENDIX E O THE BERKELEY COUNTY STORMWATER DESIGN STANDARDS MANUAL

4) ADEQUATE EROSION SEDIMENT CONTROL WILL BE MAINTAINED ON SITE OR THE DURATION OF CONSTRUCTION ACTIVITIES.


5) STABILIZATION MEASURES SHALL BE INITIATED AS SOON AS PRACTICABLE IN PORTIONS OF THE SITE WHERE CONSTRUCTION ACTIVITIES HAVE TEMPORALLY OR PERMANENTLY CEASED, BUT IN NO CASE NO MORE THAN FOURTEEN DAYS AFTER WORK HAS CEASED, UNLESS ACTIVITY IN THAT PORTION OF THE SITE WILL RESUME WITHIN TWENTY ONE DAYS. EXISTING AND NATURAL VEGETATION SHOULD BE PRESERVED AS

6) THE TOTAL DISTURBED AREA FOR THIS SITE IS 0.396 ACRES.


U.S. HIGHWAY 52

SOUTH GOOSE CREEK BOULEVARD


(150' R/W)

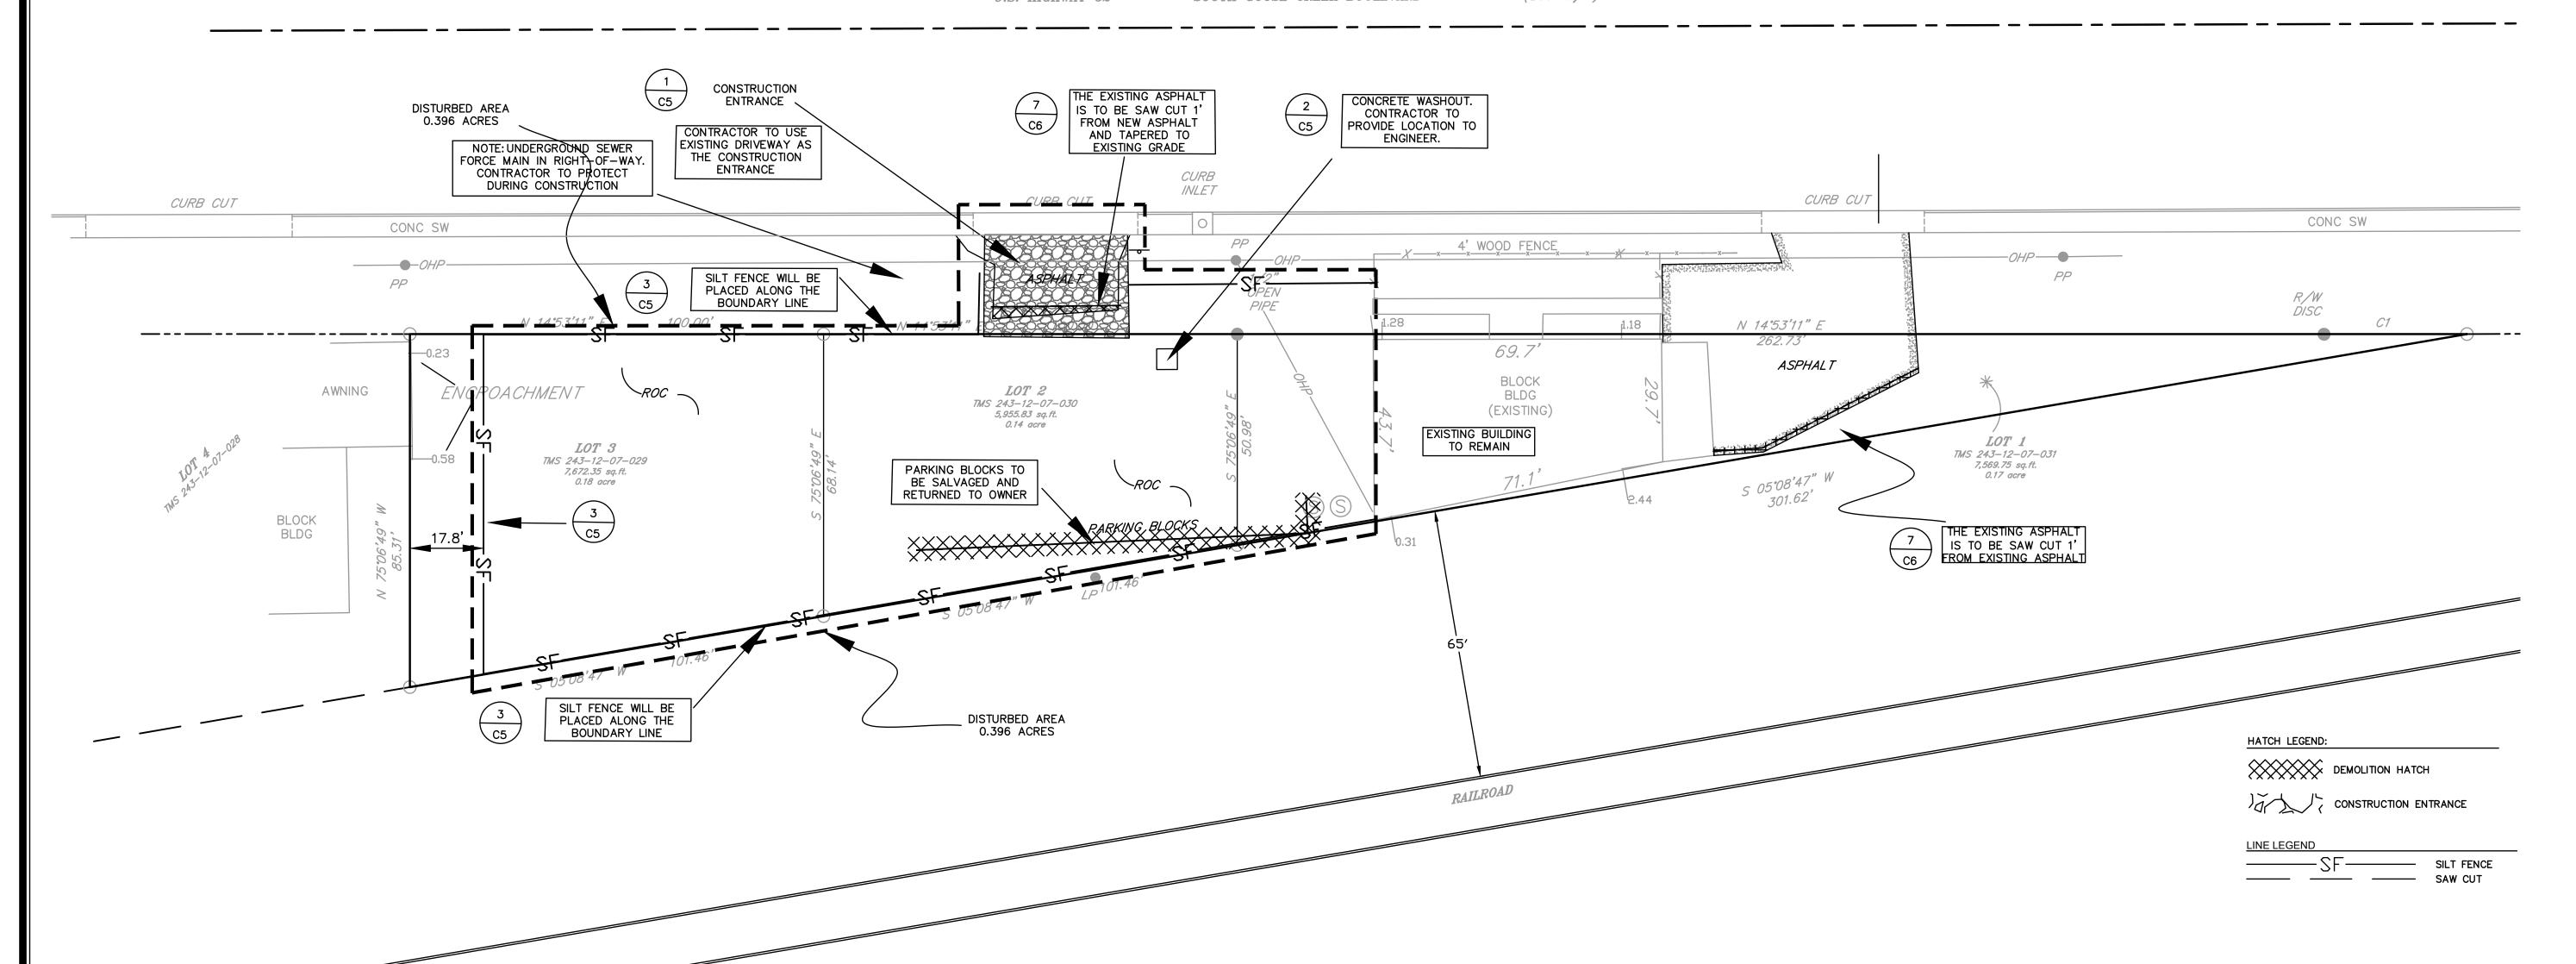


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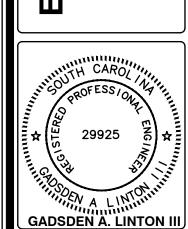


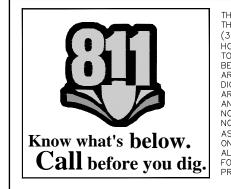THE SOUTH CAROLINA STATE LAW REQUIRES THAT EXCAVATORS GIVE A 72—HOUR NOTICE, (3 WORKING DAYS EXCLUDING WEEKENDS AND HOLIDAYS), FOR THE LOCATORS TO GET OUT TO MARK THE AREA. AFTER A TICKET HAS BEEN PROCESSED, YOU WILL KNOW WHEN YOU ARE LEGALLY FREE TO PROCEED WITH THE DIGGING WORK AND WHICH UTILITIES IN THE AREA P.U.P.S. WILL BE NOTIFYING FOR YOU. ANY UTILITIES THAT P.U.P.S. DOES NOT NOTIFY, YOU WILL BE RESPONSIBLE FOR NOTIFYING DIRECTLY THE UTILITY COMPANIES NOTIFY, YOU WILL BE RESPONSIBLE FOR NOTIFYING DIRECTLY. THE UTILITY COMPANIES ASK THAT YOU LEAVE A 2 1/2 FEET MARGIN ON EACH SIDE OF A MARKED UTILITY LINE. ALSO NOTE THAT YOUR REQUEST IS GOOD FOR 15 WORKING DAYS AFTER IT HAS BEEN



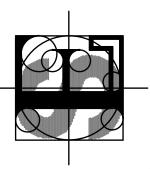

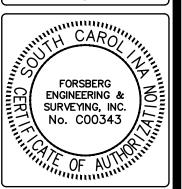OMLI' BLVD. 0



GADSDEN A. LINTON II DATE **NOVEMBER 8, 2018** DRAWN/CHECKED CLH/GAL

LAST REVISED **JANUARY 22, 2019** 

APPROVED

GRAPHIC SCALE


( IN FEET )


1 inch = 20 ft.


GAL

SCALE 1" = 20' PROJECT NO.

5327 SHEET NUMBER

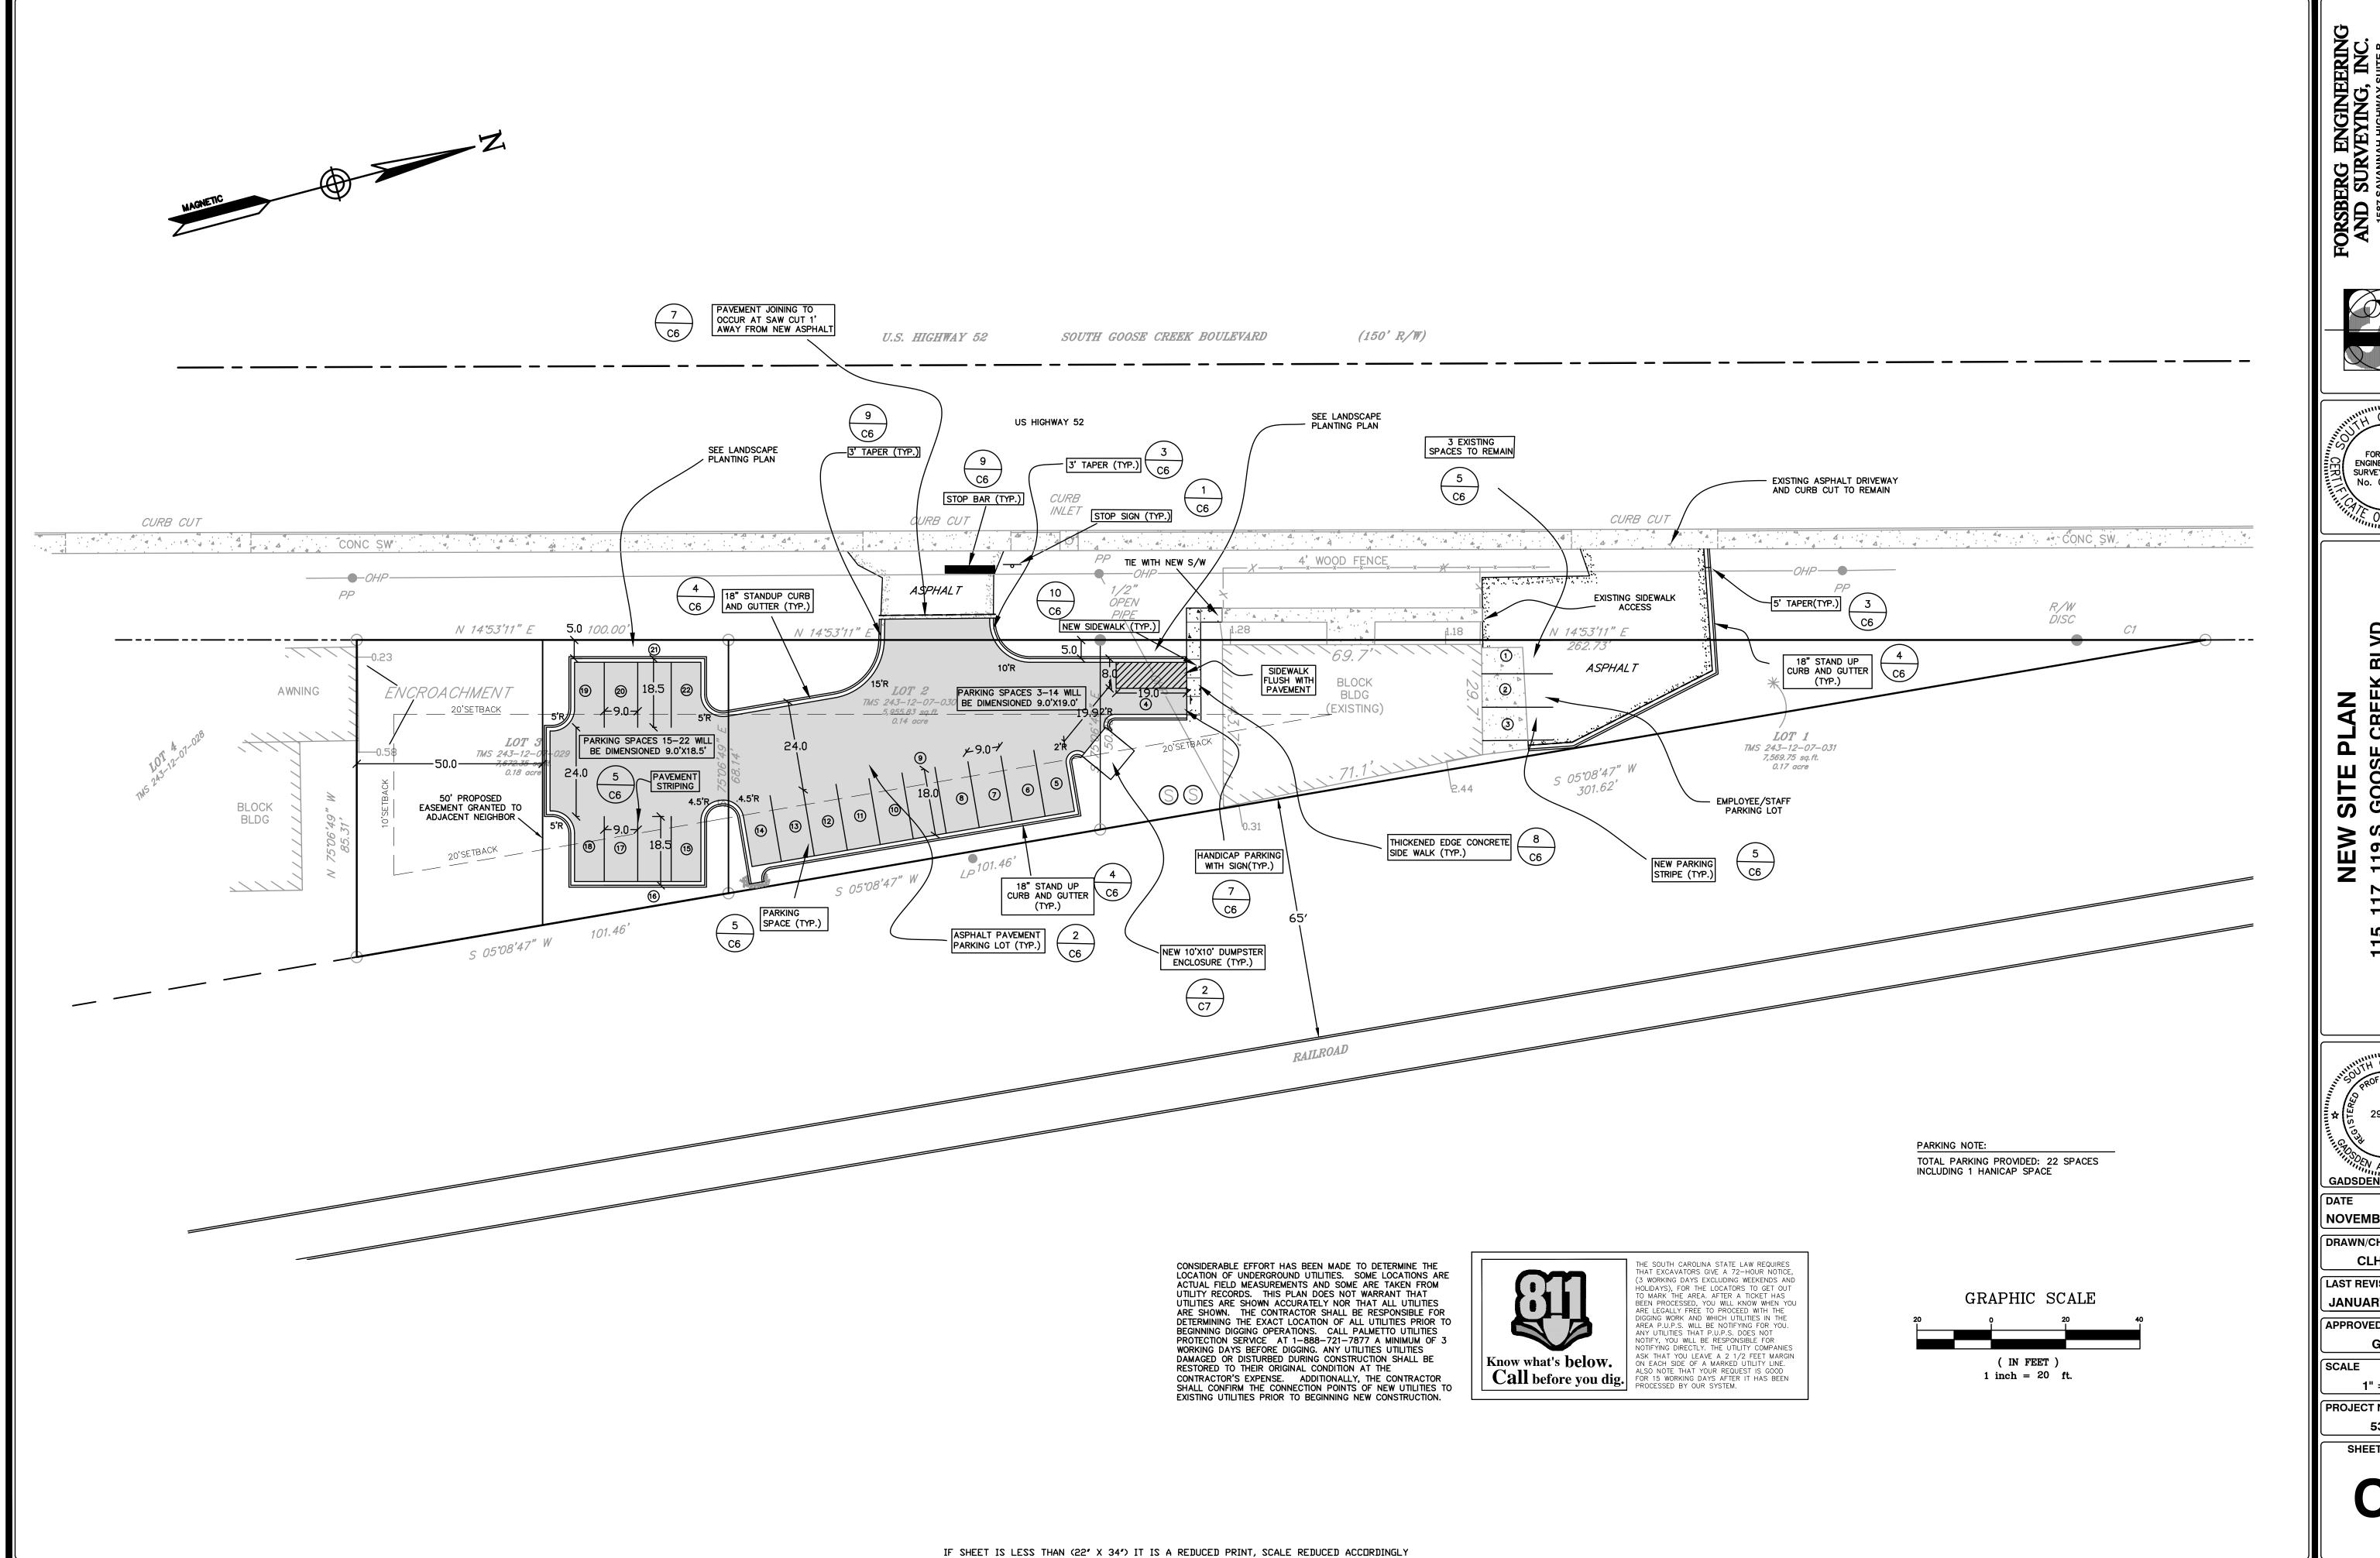

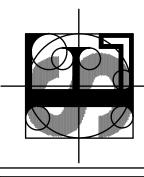

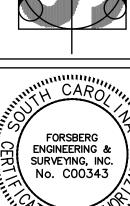



GADSDEN A. LINTON III

**NOVEMBER 8, 2018** 

DRAWN/CHECKED CLH/GAL

LAST REVISED **JANUARY 22, 2019** 

APPROVED GAL

1" = 20'

PROJECT NO. 5327


SHEET NUMBER

MAGNETIC


LEGEND — 34 — CONTOUR CENTERLINE RD NEW STORM DRAIN FINISHED GRADE RIGHT OF WAY EXISTING GRADE DRAINAGE FLOW INDICATOR POWER POLE OVERHEAD POWER BUILDING 12 . S. . N. W. W. . A. ROC GRAVEL CONC CONCRETE unil SIDEWALK NEW ASPHALT RIPRAP R/W RIGHT OF WAY


U.S. HIGHWAY 52 SOUTH GOOSE CREEK BOULEVARD (15


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FORSBERG ENGINEERING & SURVEYING, INC. No. C00343

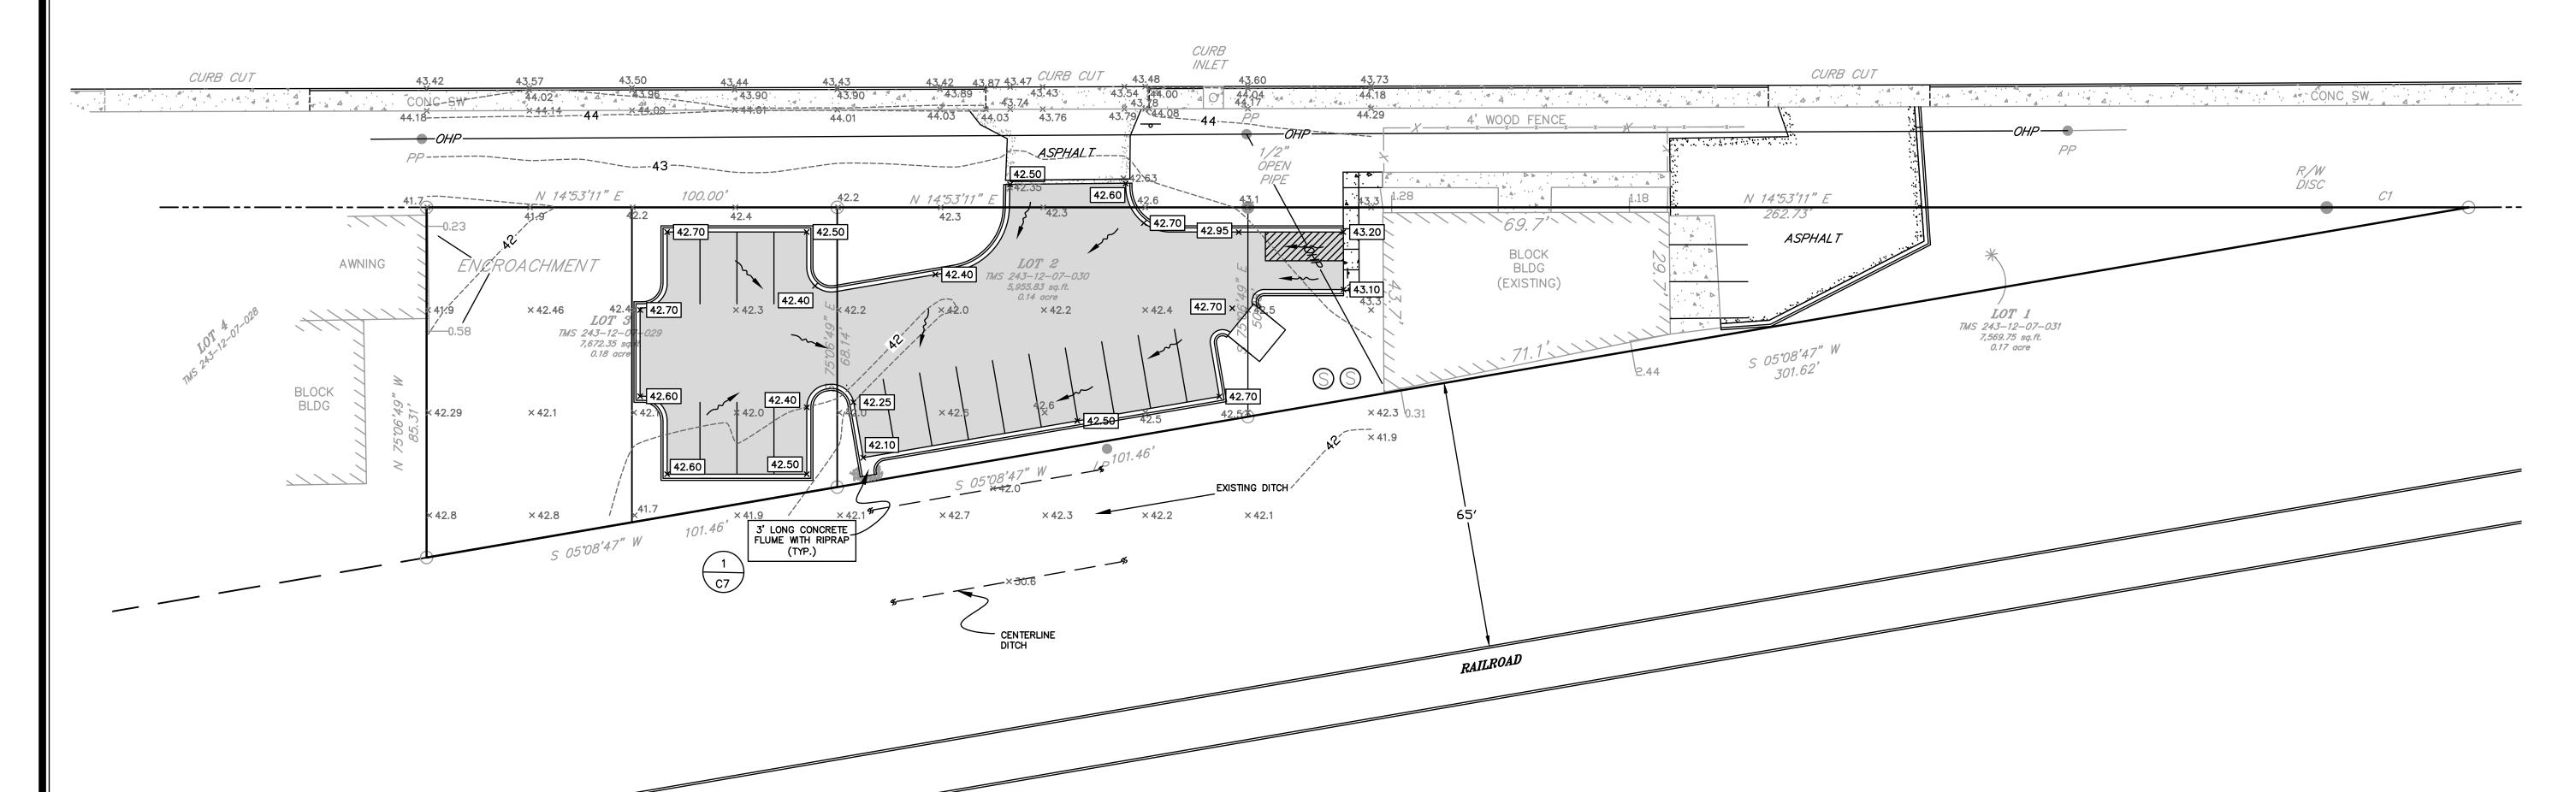DRAINAGE PLAN 300SE CREEK BLVD. 300SE CREEK

115, 117, 119 S. GOOSE CRE
CITY OF GOOSE CREE
BERKELEY COUNTY, SOUTH CARO

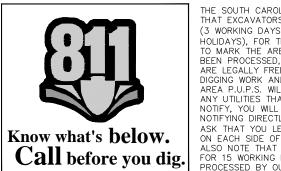

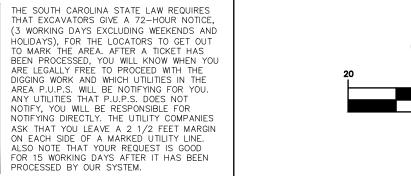DATE
NOVEMBER 8, 2018
DRAWN/CHECKED
CLH/GAL

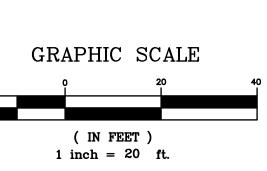CLH/GAL

LAST REVISED

JANUARY 22, 20

JANUARY 22, 2019

APPROVED

PPROVED GAL


SCALE

1" = 20'

PROJECT NO.

5327
SHEET NUMBER

C4

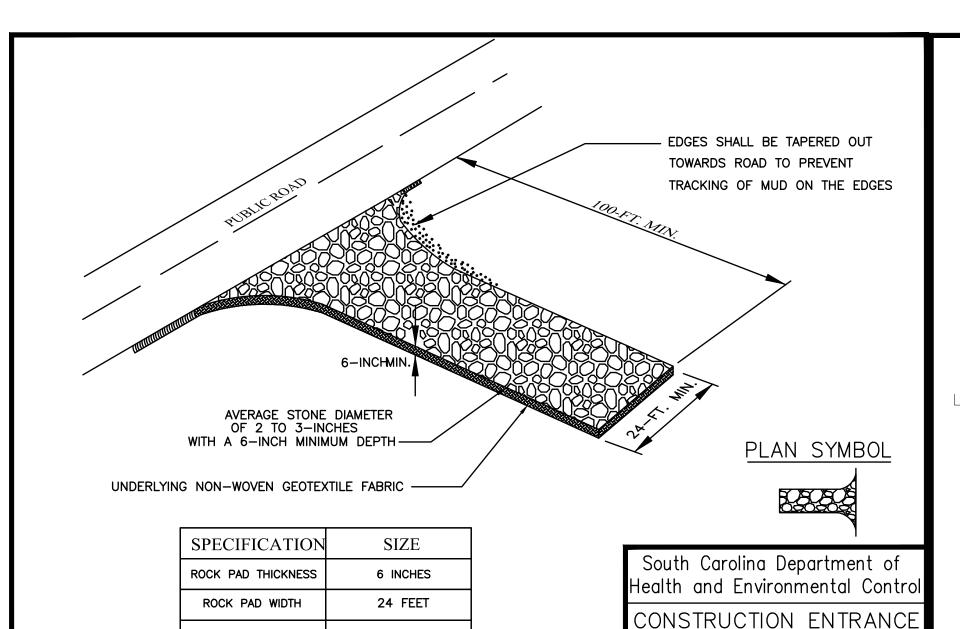

100 FEET

D = 2-3 INCHES

CONSTRUCTION ENTRANCE - GENERAL NOTES 1. Stabilized construction entrances should be used at all points where traffic will egress/ingress a construction site onto a public road or any impervious surfaces, such as parking lots.

ROCK PAD LENGTH

ROCK PAD STONE SIZE

- Install a non-woven geotextile fabric prior to placing any
- 3. Install a culvert pipe across the entrance when needed to provide positive drainage.
- The entrance shall consist of 2-inch to 3-inch D50 stone placed at a minimum depth of 6-inches.
- 100-feet long, and may be modified as necessary to accommodate site constraints.
- 6. The edges of the entrance shall be tapered out towards the road to prevent tracking at the edge of the entrance.
- Divert all surface runoff and drainage from the stone pad to a sediment trap or basin or other sediment trapping structure.

Minimum dimensions of the entrance shall be 24-feet wide by

8. Limestone may not be used for the stone pad.

CONSTR. ENTRANCE - INSPECTION & MAINTENANCE 1. The key to functional construction entrances is weekly inspections, routine maintenance, and regular sediment removal.

TANDARD DRAVING NO. SC-06 PAGE 1 of 2


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- 2. Regular inspections of construction entrances shall be conducted once every calendar week and, as recommended, within 24-hours after each rainfall even that produces 1/2-inch or more of precipitation.
- 3. During regular inspections, check for mud and sediment buildup and pad integrity. Inspection frequencies may need to be more frequent during long periods of wet weather.
- 4. Reshape the stone pad as necessary for drainage and runoff
- 5. Wash or replace stones as needed and as directed by site inspector. The stone in the entrance should be washed or replaced whenever the entrance fails to reduce the amount of mud being carried off-site by vehicles. Frequent washing will extend the useful life of stone pad.
- 6. Immediately remove mud and sediment tracked or washed onto adjacent impervious surfaces by brushing or sweeping. Flushing should only be used when the water can be discharged to a
- 7. During maintenance activities, any broken pavement should be epaired immediately.
- 8. Construction entrances should be removed after the site has reached final stabilization. Permanent vegetation should replace areas from which construction entrances have been removed, unless area will be converted to an impervious surface to serve post-construction.



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CONSTRUCTION ENTRANCE STANDARD DRAWING NO. SC-06 PAGE 2 of 2 GENERAL NOTES FEBRUARY 2014




SCDHEC NPDES STANDARD NOTES (2012 CGP)
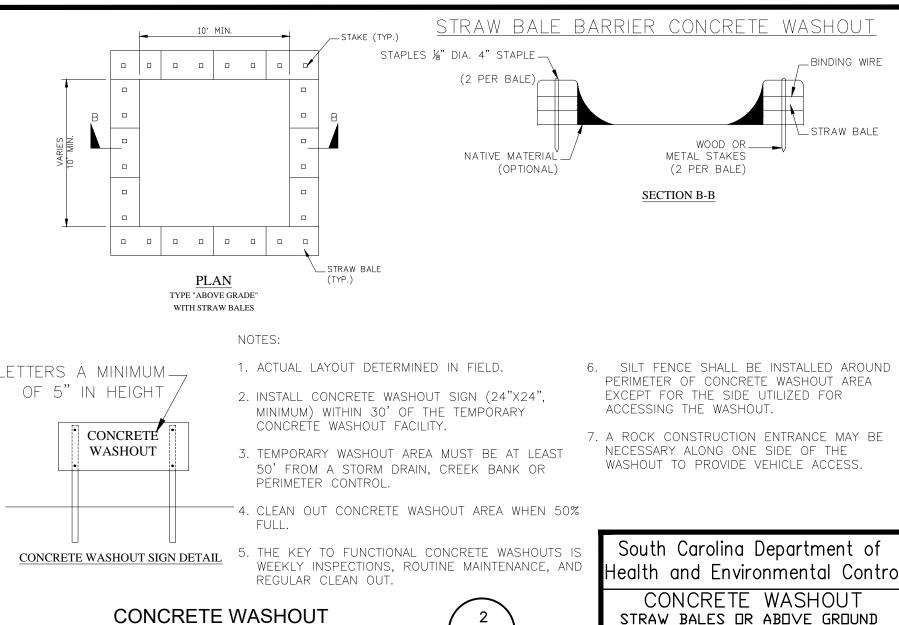
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- 1. IF NECESSARY, SLOPES, WHICH EXCEED EIGHT (8) VERTICAL FEET SHOULD BE STABILIZED WITH SYNTHETIC OR VEGETATIVE MATS, IN ADDITION TO HYDROSEEDING. IT MAY BE NECESSARY TO INSTALL TEMPORARY SLOPE DRAINS DURING CONSTRUCTION. TEMPORARY BERMS MAY BE NEEDED UNTIL THE SLOPE IS BROUGHT TO GRADE.
- 2. STABILIZATION MEASURES SHALL BE INITIATED AS SOON AS PRACTICABLE IN PORTIONS OF THE SITE WHERE CONSTRUCTION ACTIVITIES HAVE TEMPORARILY OR PERMANENTLY CEASED, BUT IN NO CASE MORE THAN FOURTEEN (14) DAYS AFTER WORK HAS CEASED, EXCEPT AS STATED BELOW. • WHERE STABILIZATION BY THE 14th DAY IS PRECLUDED BY SNOW COVER OR FROZEN GROUND CONDITIONS STABILIZATION MEASURES MUST BE INITIATED AS SOON AS PRACTICABLE.

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- WHERE CONSTRUCTION ACTIVITY ON A PORTION OF THE SITE IS TEMPORARILY CEASED, AND EARTH-DISTURBING ACTIVITIES WILL BE RESUMED
- 3. ALL SEDIMENT AND EROSION CONTROL DEVICES SHALL BE INSPECTED ONCE CALENDAR EVERY WEEK. IF PERIODIC INSPECTION OR OTHER INFORMATION INDICATES THAT A BMP HAS BEEN INAPPROPRIATELY, OR INCORRECTLY, THE PERMITTEE MUST ADDRESS THE NECESSARY REPLACEMENT OR MODIFICATION REQUIRED TO CORRECT THE BMP WITHIN 48 HOURS OF IDENTIFICATION
- 4. PROVIDE SILT FENCE AND/OR OTHER CONTROL DEVICES. AS MAY BE REQUIRED. TO CONTROL SOIL EROSION DURING UTILITY CONSTRUCTION. ALL DISTURBED AREAS SHALL BE CLEANED. GRADED. AND STABILIZED WITH GRASSING IMMEDIATELY AFTER THE UTILITY INSTALLATION. FILL, COVER, AND TEMPORARY SEEDING AT THE END OF EACH DAY ARE RECOMMENDED. IF WATER IS ENCOUNTERED WHILE TRENCHING, THE WATER SHOULD BE FILTERED TO REMOVE SEDIMENT BEFORE BEING PUMPED BACK INTO ANY WATERS OF THE STATE.
- 5. ALL EROSION CONTROL DEVICES SHALL BE PROPERLY MAINTAINED DURING ALL PHASES OF CONSTRUCTION UNTIL THE COMPLETION OF ALL CONSTRUCTION ACTIVITIES AND ALL DISTURBED AREAS HAVE BEEN STABILIZED. ADDITIONAL CONTROL DEVICES MAY BE REQUIRED DURING CONSTRUCTION IN ORDER TO CONTROL EROSION AND/OR OFFSITE SEDIMENTATION. ALL TEMPORARY CONTROL DEVICES SHALL BE REMOVED ONCE CONSTRUCTION IS COMPLETE AND THE SITE IS STABILIZED.
- 6. THE CONTRACTOR MUST TAKE NECESSARY ACTION TO MINIMIZE THE TRACKING OF MUD ONTO PAVED ROADWAY(S) FROM CONSTRUCTION AREAS AND THE GENERATION OF DUST. THE CONTRACTOR SHALL DAILY REMOVE MUD/SOIL FROM PAVEMENT, AS MAY BE REQUIRED.
- 7. RESIDENTIAL SUBDIVISIONS REQUIRE EROSION CONTROL FEATURES FOR INFRASTRUCTURE AS WELL AS FOR INDIVIDUAL LOT CONSTRUCTION. INDIVIDUAL PROPERTY OWNERS SHALL FOLLOW THESE PLANS DURING CONSTRUCTION OR OBTAIN APPROVAL OF AN INDIVIDUAL PLAN IN ACCORDANCE WITH S.C. REG. 72-300 ET SEQ. AND SCR100000.
- 8. TEMPORARY DIVERSION BERMS AND/OR DITCHES WILL BE PROVIDED AS NEEDED DURING CONSTRUCTION TO PROTECT WORK AREAS FROM UPSLOPE RUNOFF AND/OR TO DIVERT SEDIMENT-LADEN WATER TO APPROPRIATE TRAPS OR STABLE OUTLETS.
- 9. ALL WATERS OF THE STATE (WOS). INCLUDING WETLANDS. ARE TO BE FLAGGED OR OTHERWISE CLEARLY MARKED IN THE FIELD. A DOUBLE ROW OF SILT FENCE IS TO BE INSTALLED IN ALL AREAS WHERE A 50-FOOT BUFFER CAN'T BE MAINTAINED BETWEEN THE DISTURBED AREA AND ALL WOS. A 10-FOOT BUFFER SHOULD BE MAINTAINED BETWEEN THE LAST ROW OF SILT FENCE AND ALL WOS.
- 10. LITTER, CONSTRUCTION DEBRIS, OILS, FUELS, AND BUILDING PRODUCTS WITH SIGNIFICANT POTENTIAL FOR IMPACT (SUCH AS STOCKPILES OF FRESHLY TREATED LUMBER) AND CONSTRUCTION CHEMICALS THAT COULD BE EXPOSED TO STORM WATER MUST BE PREVENTED FROM BECOMING A POLLUTANT SOURCE IN STORM WATER DISCHARGES.
- 11. A COPY OF THE SWPPP, INSPECTIONS RECORDS, AND RAINFALL DATA MUST BE RETAINED AT THE CONSTRUCTION SITE OR A NEARBY LOCATION EASILY ACCESSIBLE DURING NORMAL BUSINESS HOURS. FROM THE DATE OF COMMENCEMENT OF CONSTRUCTION ACTIVITIES TO THE DATE THAT FINAL STABILIZATION IS REACHED.
- 12. INITIATE STABILIZATION MEASURES ON ANY EXPOSED STEEP SLOPE (3H:1V OR GREATER) WHERE LAND-DISTURBING ACTIVITIES HAVE PERMANENTLY OR TEMPORARILY CEASED, AND WILL NOT RESUME FOR A PERIOD OF 7 CALENDAR DAYS.
- 13. MINIMIZE SOIL COMPACTION AND, UNLESS INFEASIBLE, PRESERVE TOPSOIL.
- 14. MINIMIZE THE DISCHARGE OF POLLUTANTS FROM EQUIPMENT AND VEHICLE WASHING. WHEEL WASH WATER. AND OTHER WASH WATERS. WASH WATERS MUST BE TREATED IN A SEDIMENT BASIN OR ALTERNATIVE CONTROL THAT PROVIDES EQUIVALENT OR BETTER TREATMENT PRIOR TO
- 15. MINIMIZE THE DISCHARGE OF POLLUTANTS FROM DEWATERING OF TRENCHES AND EXCAVATED AREAS. THESE DISCHARGES ARE TO BE ROUTED THROUGH APPROPRIATE BMPs (SEDIMENT BASIN, FILTER BAG, ETC.).
- 16. THE FOLLOWING DISCHARGES FROM SITES ARE PROHIBITED:
- WASTEWATER FROM WASHOUT OF CONCRETE, UNLESS MANAGED BY AN APPROPRIATE CONTROL; WASTEWATER FROM WASHOUT AND CLEANOUT OF STUCCO, PAINT, FORM RELEASE OILS, CURING COMPOUNDS AND OTHER CONSTRUCTION MATERIALS;
- FUELS. OILS. OR OTHER POLLUTANTS USED IN VEHICLE AND EQUIPMENT OPERATION AND MAINTENANCE: AND SOAPS OR SOLVENTS USED IN VEHICLE AND EQUIPMENT WASHING.
- 17. AFTER CONSTRUCTION ACTIVITIES BEGIN, INSPECTIONS MUST BE CONDUCTED AT A MINIMUM OF AT LEAST ONCE EVERY CALENDAR WEEK AND MUST BE CONDUCTED UNTIL FINAL STABILIZATION IS REACHED ON ALL AREAS OF THE CONSTRUCTION SITE.
- 18. IF EXISTING BMPs NEED TO BE MODIFIED OR IF ADDITIONAL BMPs ARE NECESSARY TO COMPLY WITH THE REQUIREMENTS OF THIS PERMIT AND/OR SC'S WATER QUALITY STANDARDS, IMPLEMENTATION MUST BE COMPLETED BEFORE THE NEXT STORM EVENT WHENEVER PRACTICABLE. IF IMPLEMENTATION BEFORE THE NEXT STORM EVENT IS IMPRACTICABLE, THE SITUATION MUST BE DOCUMENTED IN THE SWPPP AND ALTERNATIVE BMPs MUST BE IMPLEMENTED AS SOON AS REASONABLY POSSIBLE
- 19. A PRE-CONSTRUCTION CONFERENCE MUST BE HELD FOR EACH CONSTRUCTION SITE WITH AN APPROVED ON-SITE SWPPP PRIOR TO THE IMPLEMENTATION OF CONSTRUCTION ACTIVITIES. FOR NON-LINEAR PROJECTS THAT DISTURB 10 ACRES OR MORE THIS CONFERENCE MUST BE HELD ON-SITE UNLESS THE DEPARTMENT HAS APPROVED OTHERWISE.



SILT FENCE — GENERAL NOTES

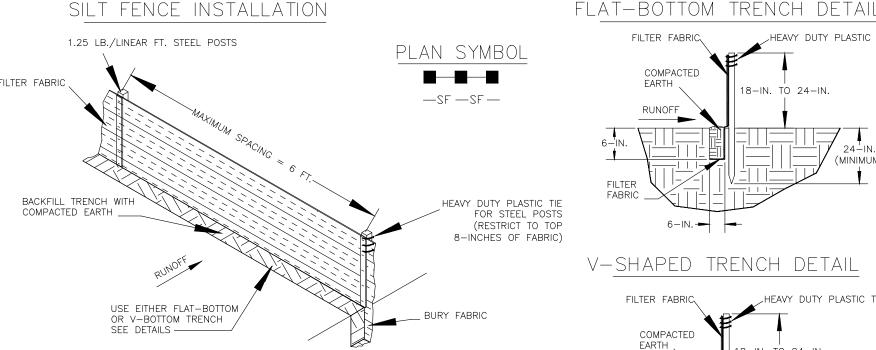1. Do not place silt fence across channels or in other areas subject to concentrated flows. Silt fence should not be used as a velocity control BMP. Concentrated flows are any flows greater than 0.5 cfs.

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2. Maximum sheet or overland flow path length to the silt fence shall be 100—feet.

3. Maximum slope steepness (normal [perpendicular] to the fence line) shall be 2:1.

Silt fence joints, when necessary, shall be completed by one of the following options: -Wrap each fabric together at a support post with both ends fastened to the post, with a 1-foot -Overlap silt fence by installing 3-feet passed the support post to which the new silt fence roll is attached. Attach old roll to new roll with heavy-duty plastic ties; or, — Overlap entire width of each silt fence roll from one support post to the next support post.

Attach filter fabric to the steel posts using heavy—duty plastic ties that are evenly spaced within the top

. Install Silt Fence Checks (Tie—Backs) every 50—100 feet, dependent on slope, along silt fence that is installed

6. Install the silt fence perpendicular to the direction of the stormwater flow and place the silt fence the proper distance from the toe of steep slopes to provide sediment storage and access for maintenance and cleanout

with slope and where concentrated flows are expected or are documented along the proposed/installed silt DELINEATED AS --- SF --- ON PLANS

V-SHAPED TRENCH DETAIL FILTER FABRIC, HEAVY DUTY PLASTIC TIES RUNOFF (MINIMUM) BURY FILTER FABRIC AT LEAST 12-INCHES

HEAVY DUTY PLASTIC TIES

(MINIMUM)

South Carolina Department of **l**Health and Environmental Contro

SILT FENCE

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Silt Fence posts must be 48-inch long steel posts that meet, at a minimum, the following physical characteristics.

-Include a standard "T" section with a nominal face width of 1.38inches and a nominal "T" length of 1.48—inches. - Weigh 1.25 pounds per foot (± 8%)

— Composed of a high strength steel with a minimum yield strength

- . Posts shall be equipped with projections to aid in fastening of filter fabric.
- Steel posts may need to have a metal soil stabilization plate welded near the bottom when installed along steep slopes or installed in loose soils. The plate should have a minimum cross section of 17-square inches and be composed of 15 gauge steel, at a minimum. The metal soil stabilization plate should be
- . Install posts to a minimum of 24-inches. A minimum height of 1- to 2inches above the fabric shall be maintained, and a maximum height of 3 feet shall be maintained above the ground.
- 5. Post spacing shall be at a maximum of 6-feet on center.

### SILT FENCE - FABRIC REQUIREMENTS

- Silt fence must be composed of woven geotextile filter fabric that consists of the following requirements:
- —Composed of fibers consisting of long chain synthetic polymers of at least 85% by weight of polyolefins, polyesters, or polyamides that are formed into a network such that the filaments or yarns retain dimensional stability relative to
- -Free of any treatment or coating which might adversely alter its physical
- Free of any defects or flaws that significantly affect its physical and/or filtering properties; and,
- Have a minimum width of 36-inches.
- . Use only fabric appearing on SC DOT's Qualified Products Listing (QPL), Approval Sheet #34, meeting the requirements of the most current edition of the SC DOT Standard Specifications for Highway Construction.
- 12-inches of the fabric should be placed within excavated trench and toed in when the trench is backfilled.
- 4. Filter Fabric shall be purchased in continuous rolls and cut to the length of the barrier to avoid joints. 5. Filter Fabric shall be installed at a minimum of 24—inches above the ground.

- Removed sediment shall be placed in stockpile storage areas or spread thinly across disturbed area. Stabilize the removed sediment
- 6. Check for areas where stormwater runoff has eroded a channel
- beneath the silt fence, or where the fence has sagged or collapsed due to runoff overtopping the silt fence. Install checks/tie-backs and/or reinstall silt fence, as necessary.

SILT FENCE - INSPECTION & MAINTENANCE

1. The key to functional silt fence is weekly inspections, routine

2. Regular inspections of silt fence shall be conducted once every

rainfall even that produces 1/2—inch or more of precipitation.

calendar week and, as recommended, within 24-hours after each

3. Attention to sediment accumulations along the silt fence is extremely

4. Remove accumulated sediment when it reaches 1/3 the height of the

important. Accumulated sediment should be continually monitored and

maintenance, and regular sediment removal.

removed when necessary.

- 7. Check for tears within the silt fence, areas where silt fence has begun to decompose, and for any other circumstance that may render the silt fence ineffective. Removed damaged silt fence and reinstall new silt fence immediately.
- 8. Silt fence should be removed within 30 days after final stabilization is achieved and once it is removed, the resulting disturbed area shall be permanently stabilized.

TYPICAL SILT FENCE

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SILT FENCE

STANDARD DRAVING ND.SC-03 PAGE 2 of 2 GENERAL NOTES FEBRUARY 2014
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ENGINEERING &

SURVEYING, INC

No. C00343

GADSDEN A. LINTON **NOVEMBER 8, 2018** 

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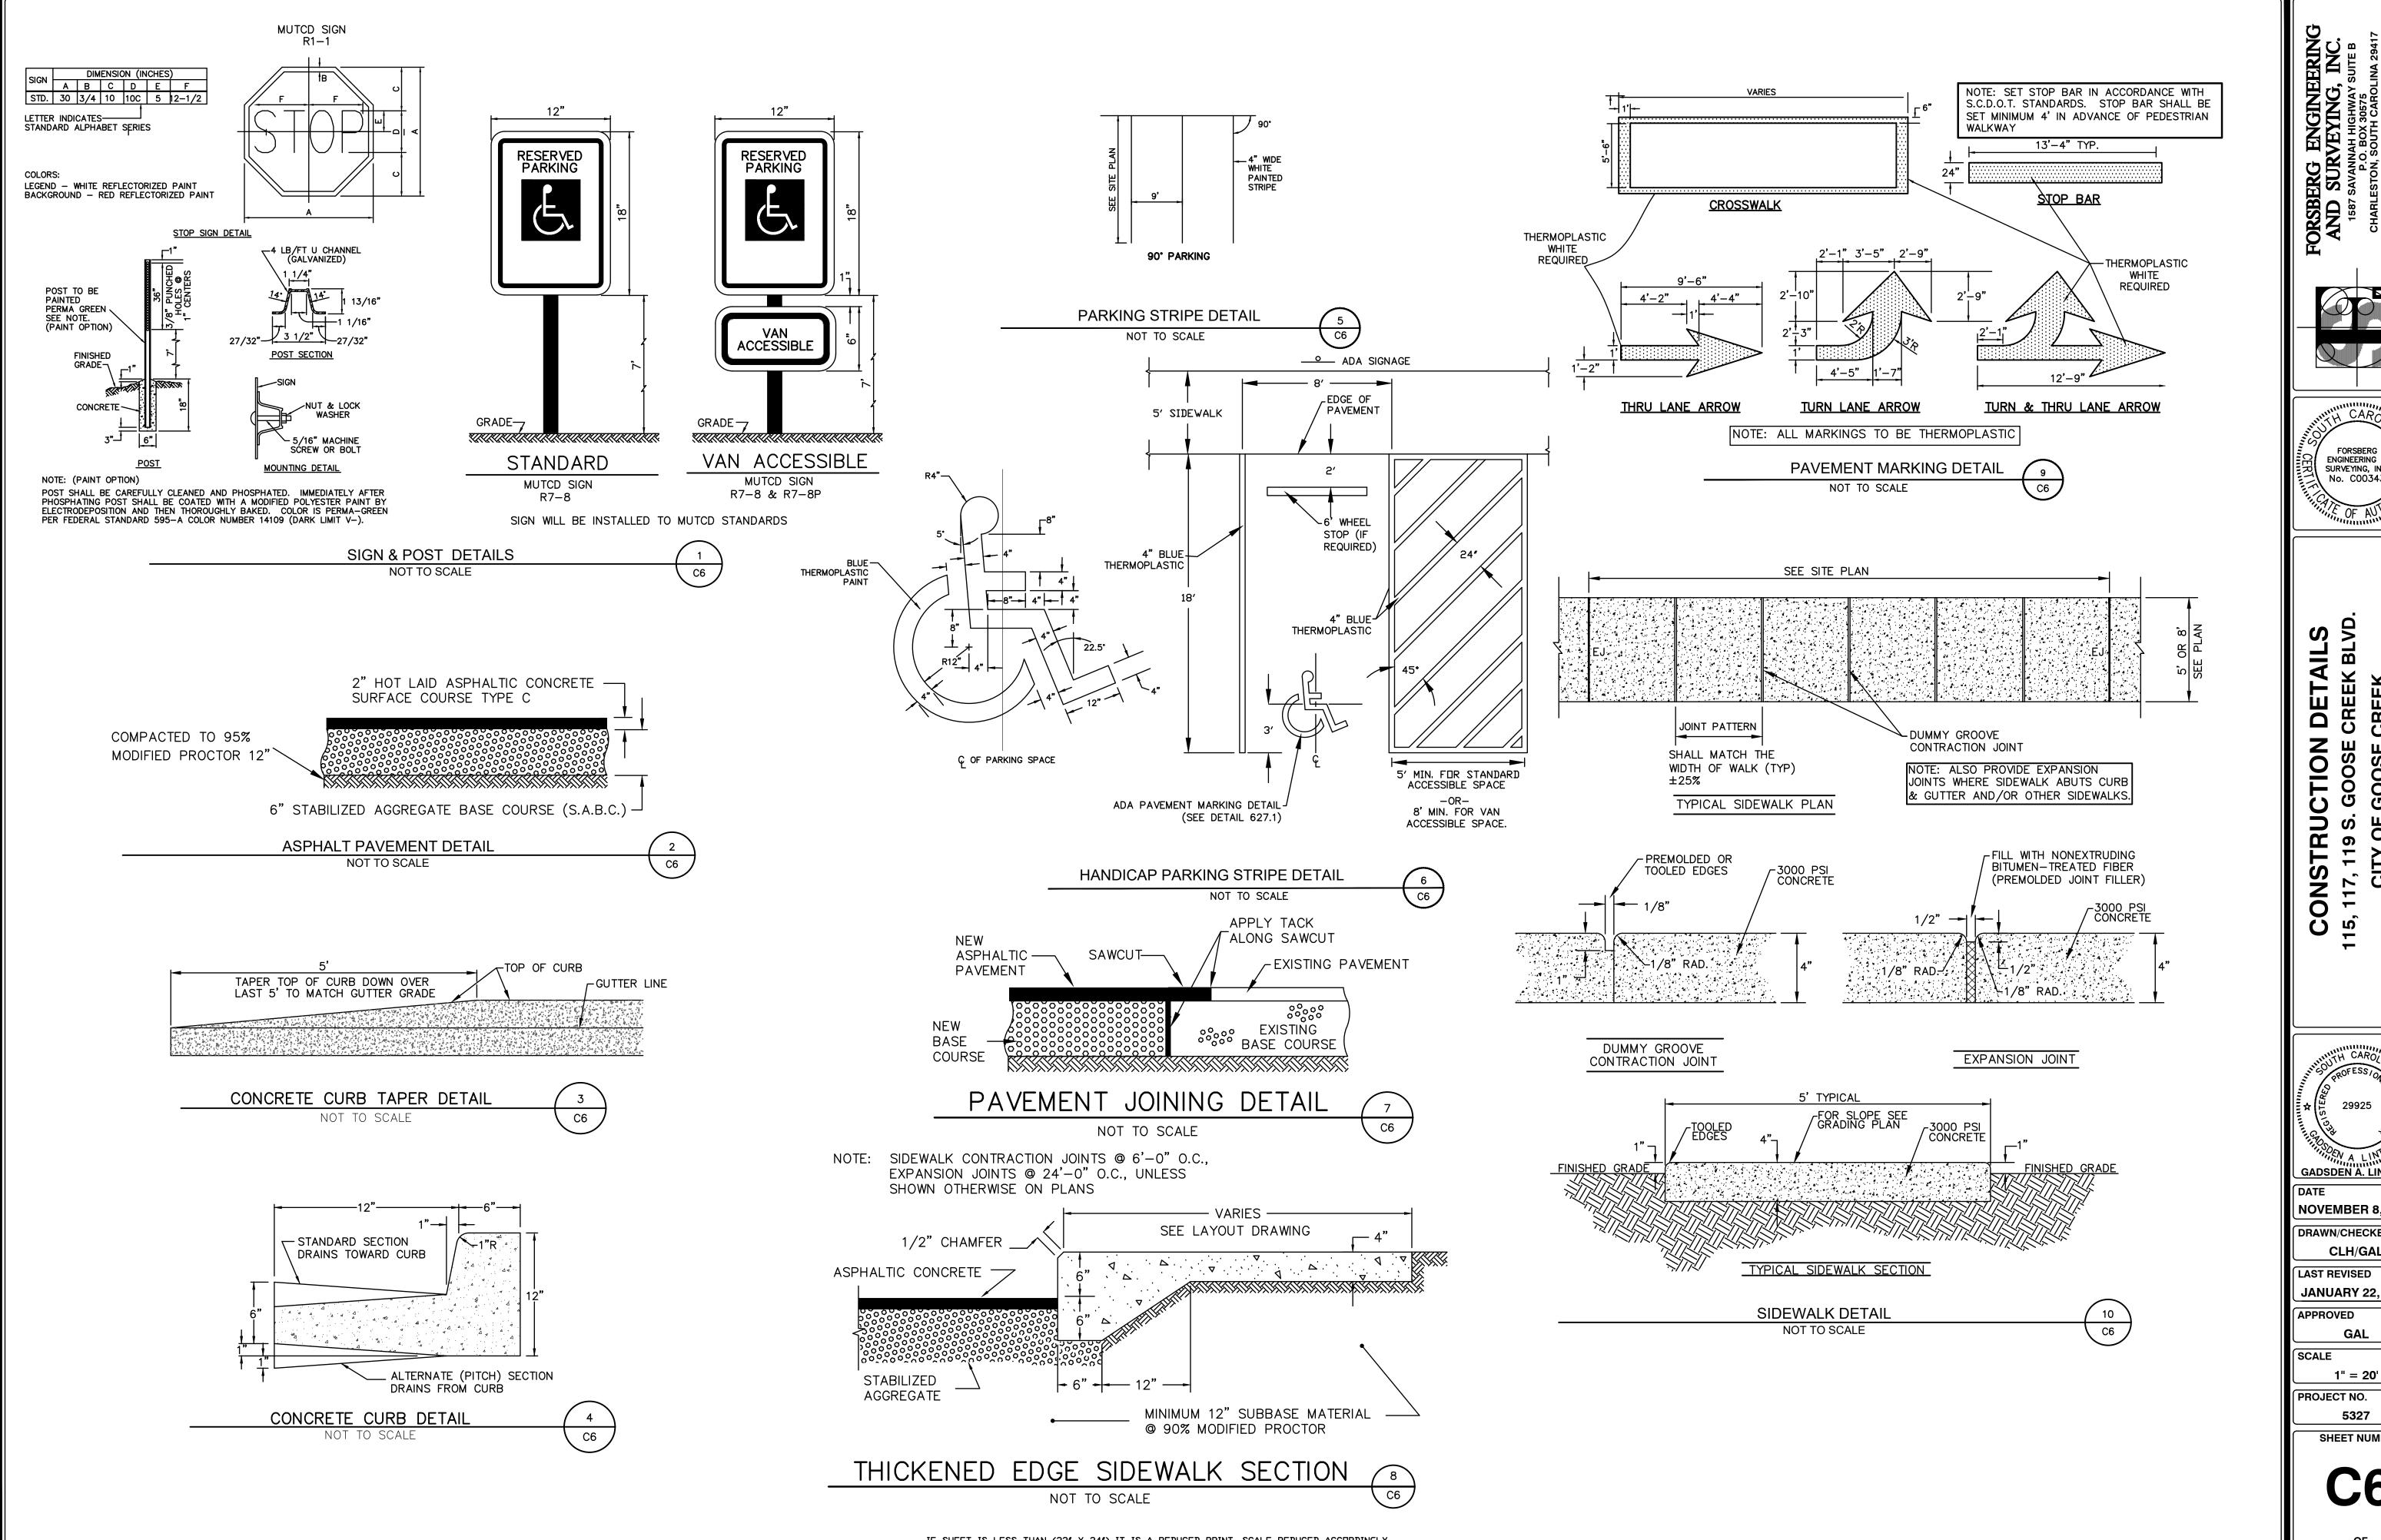
LAST REVISED **JANUARY 22, 2019** APPROVED


> GAL SCALE

1" = 20' PROJECT NO.

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**SHEET NUMBER** 



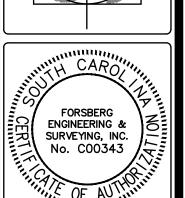

GADSDEN A. LINTON I


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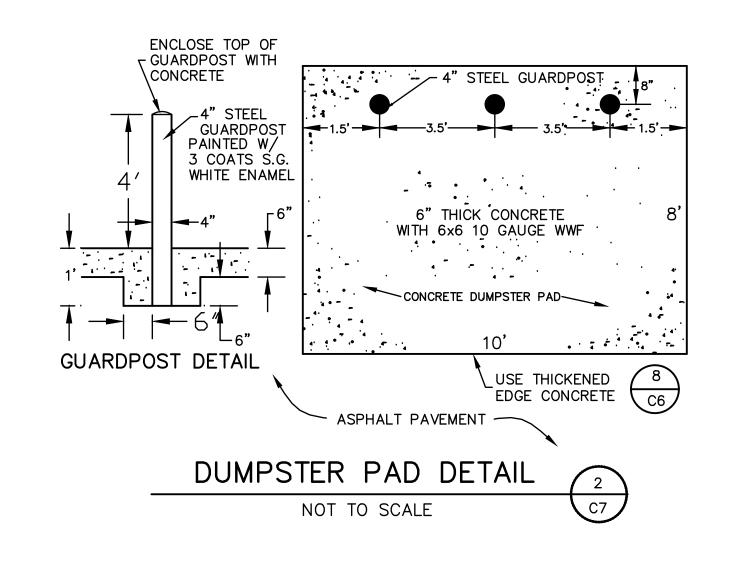
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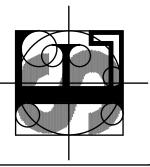
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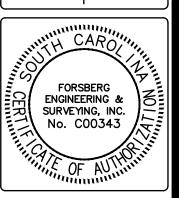
IF SHEET IS LESS THAN (22" X 34") IT IS A REDUCED PRINT, SCALE REDUCED ACCURDINGLY



NOT TO SCALE





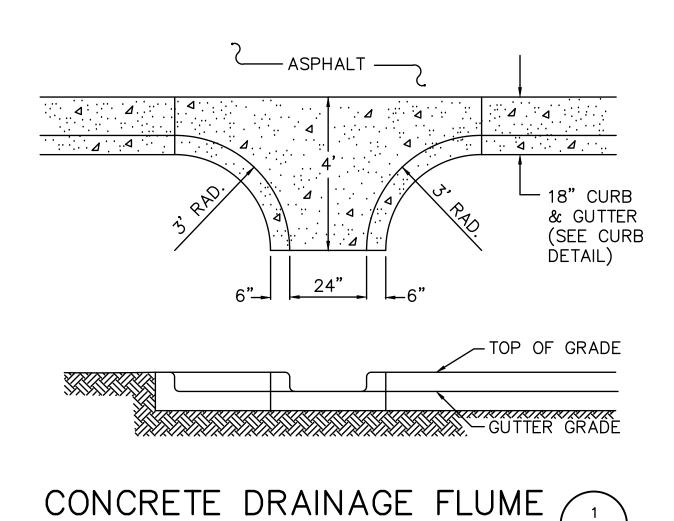

GADSDEN A. LINTON III

**NOVEMBER 8, 2018** DRAWN/CHECKED

CLH/GAL LAST REVISED

**JANUARY 22, 2019** APPROVED

GAL

SCALE 1" = 20'

PROJECT NO.

SHEET NUMBER

